

## REPUBLIC OF THE PHILIPPINES NATIONAL POWER CORPORATION

(Pambansang Korporasyon sa Elektrisidad)

## **BID DOCUMENTS**

Name of Project: SUPPLY, DELIVERY, CONSTRUCTION,

INSTALLATION, TESTING AND COMMISSIONING

OF 10MVA MASBATE (MALINTA) SUBSTATION

Project Location: Malinta, Masbate

Specs No. : LuzP23Z1636Sce

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**Design and Development Department** 



# SECTION VII BILL OF QUANTITIES

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#### SUMMARY OF BILL OF QUANTITIES

Item No.	Description of Work or Materials	Work to be Done	Reference	Unit	Estimated Quantity	Unit Price in Pesos (In Words & Figures)	Total Amount (In Figures)
	TOTAL FOR ARCHITECTURAL WORKS					(P	P
	TOTAL FOR CIVIL WORKS					(P	P
	TOTAL FOR ELECTRICAL WORKS					(P)	P
	TOTAL FOR MECHANICAL WORKS					(P)	P
	TOTAL (ABC)					(P)	P

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SECTION VII - BILL OF QUANTITIES

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#### ARCHITECTURAL WORKS

		ARCHITE	CTURAL WO	RKS			
Item No.	Description of Work or Materials	Work to Be Done	Ref	Unit	Estimated Quantity	Unit Price in Pesos (Words and Figures)	Total Amount (In Figures)
l.	CONTROL HOUSE						
1.0	Wall System and Finishes						
1.1	150mm thick (6") CHB Wall including mortar, grout with 10mm Ø Rebar @ 0.60m vertical & horizontal spacing	furnish and lay	Refer to NPC TS & Drawing	sq.m.	380.0	(P)	(P)
3.1	Plain cement plaster finish (For Exterior and Interior Walls)	fu <b>m</b> ish and apply	Refer to NPC TS & Drawing	sq.m.	826.0	(P)	(P)
3.2	Vitrified glazed tiles 200mm x 200mm x 6mm thick colored including scrath coat, tile adhesive & grout	furnish and install	Refer to NPC TS & Drawing	sq.m.	10.0	(P)	(P)
2.0	Floor Finish						
2.1	Vinyl tile finish 300mm x 300mm x 3mm thick including levelling, tile adhesive & grout	fumish and install	Refer to NPC TS & Drawing	sq.m.	116.0	(P)	(P)
2.2	Vitrified unglazed tiles 200mm x 200mm x 6mm thick colored including scrath coat, tile adhesive & grout	furnish and install	Refer to NPC TS & Drawing	sq.m.	3.5	(P)	(P)
2.3	#10 Peeble washout including levelling mortar	furnish and apply	Refer to NPC TS & Drawing	sq.m.	8.0	(P)	(P)
3.0	Ceiling Finish						
3.1	6mm thick marine plywood on standard metal furring space at 0.40 O.C.B.W. and metal hangers spaced at 0.80 O.C.B	furnish and install	Refer to NPC TS & Drawing	sq.m.	120.0	(P)	(P)
Note:	The total amount shall be inclusive of Mark-Up (OCM and Profit) and VAT						

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SUPPLY, DELIVERY, CONSTRUCTION, INSTALLATION, TESTING AND COMMISSIONING OF 10MVA MASBATE

(MALINTA) SUBSTATION

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#### SECTION VII - BILL OF QUANTITIES

#### **ARCHITECTURAL WORKS**

Item No.	Description of Work or Materials	Work to Be Done	Ref	Unit	Estimated Quantity	Unit Price in Pesos (Words and Figures)	Total Amount (In Figures)
4.0	Fenestration	· · · · · · · · · · · · · · · · · · ·				•	
4.1	Doors						
	a) D-1 (2000mm x 2100mm) Aluminum and Glass Anodized Silver Aluminum, 6mm thi clear glass double swing door complete accessories and loc	furnish and install k	Refer to NPC TS & Drawing	set	1	(P)	(P)
	b) D-2 (1800mm x 2100mm)  Flush type wooden door marine plywood both sides, 2" x hard wood jamb, including heavy duty loose pin hinges, doo knob weather proof and painting	furnish and install r	Refer to NPC TS & Drawing	set	2	(P)	(P)
	c) D-3 (900mm x 2100mm) Flush type wooden door marine plywood both sides, 2" x hard wood jamb, including heavy duty loose pin hinges, doo knob weather proof and painting	furnish and install r	Refer to NPC TS & Drawing	set	3	(P)	(P)
	d) D-4 (700 x 2100mm) Flush type wooden door marine plywood both sides, 2" x hard wood jamb, including heavy duty loose pin hinges, doo knob weather proof and painting	furnish and install r	Refer to NPC TS & Drawing	set	1	)	(P)
4.2	Windows						
	a) W-1 (3600mm x 1200mm) Steel casement window, 7/6 heavy section z-bar solid mullion, 7/32" clear glass	furnish and install	Refer to NPC TS & Drawing	set	1	(P)	)
	b) W-2 (1800mm x 1200mm) Steel casement window, 7/6 heavy section z-bar solid mullion, 7/32" clear glass	furnish and install	Refer to NPC TS & Drawing	set	2	(P)	(P)
Note:	The total amount shall be inclusive of Mark-Up (OCM and Profit) and VAT						
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SUPPLY, DELIVERY, CONSTRUCTION, INSTALLATION, TESTING AND COMMISSIONING OF 10MVA MASBATE (MALINTA) SUBSTATION

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#### **ARCHITECTURAL WORKS**

item No.	Description of Work or Materials	Work to Ве Done	Ref	Unit	Estimated Quantity	Unit Price in Pesos (Words and Figures)	Total Amount (In Figures)
	c) W-3 (3000mm x 600mm) Steel casement window, 7/6 heavy section z-bar solid multion, 7/32" clear glass	furnish and install	Refer to NPC TS & Drawing	set	5	(P)	(P)
5.0	Plumbing System						
5.1	Water Closet (White Elongated) including fittings and accessories	furnish and install	Refer to NPC TS & Drawing	set	1	(P)	(P)
5.2	Lavatory (White) including fitting faucet and accessories	furnish and install	Refer to NPC TS & Drawing	set	1	(P)	(P)
5.3	Tissue Paper Holder (White) including accessories	furnish and instalt	Refer to NPC TS & Drawing	set	1	(P)	(P)
5.4	Soap Holder (White) including accessories	furnish and instali	Refer to NPC TS & Drawing	set	1	(P)	(P)
5.5	Liquid Soap Dispenser	furnish and install	Refer to NPC TS & Drawing	set	1	(P)	(P)
5.6	Single tub stainless steel kitchen sink including faucet fittings and accessories	furnish and install	Refer to NPC TS & Drawing	set	1	(P)	(P)
5.7	Shower set	furnish and install	Refer to NPC TS & Drawing	set	1	(P)	(P)
5.8	Sanitary lines: uPVC pipe series 1000 including joint fittings and solvents	design, furnish and install	Refer to NPC TS & Drawing	lot	1		(P)

Note: The total amount shall be inclusive of Mark-Up (OCM and Profit) and VAT

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SECTION VII - BILL OF QUANTITIES

#### **ARCHITECTURAL WORKS**

5.9 Downspoul: 3" (75mm) a uPVC pipe series 1000 downspout including joint fittings, solvents and brackets  5.10 Roof Drain: Removable stainless wire basket strainer  6.1 Utilities counter cabinets, 20mm thick (3/4") marine plywood including edging, framing, hardware, painting and accessories  6.2 Wall-hung cabinets, 20mm thick (3/4") marine plywood including edging, framing, hardware, painting and accessories  6.2 Wall-hung cabinets, 20mm thick (3/4") marine plywood including edging, framing, hardware, painting and accessories  6.2 For concrete surfaces  6.3 For fiberboard surfaces  6.4 Vall-hung cabinets, 20mm thick (as/4") marine plywood including edging, framing, hardware, painting and accessories  6.5 For concrete surfaces  6.6 Vall-hung cabinets, 20mm thick (as/4") marine plywood including edging, framing, hardware, painting and accessories  6.5 Painting and Varnishing  6.6 Vall-hung cabinets, 20mm thick (as/4") marine plywood including edging, framing, hardware, painting and accessories  6.7 Painting and Varnishing  6.8 Fer to NPC (bt. 1)  6.9 TS & Drawing  7.1 For wooden surfaces  6.9 Vall-hung cabinets, 20mm thick (pp. 1)  7.1 For wooden surfaces  6.9 Vall-hung cabinets, 20mm thick (pp. 1)  7.1 For wooden surfaces  6.9 Vall-hung cabinets, 20mm thick (pp. 1)  7.1 For wooden surfaces  6.9 Vall-hung cabinets, 20mm thick (pp. 1)  7.1 For wooden surfaces  6.9 Vall-hung cabinets, 20mm thick (pp. 1)  7.1 For wooden surfaces  6.9 Vall-hung cabinets, 20mm thick (pp. 1)  7.1 For wooden surfaces  6.9 Vall-hung cabinets, 20mm thick (pp. 1)  7.1 For wooden surfaces  6.9 Vall-hung cabinets, 20mm thick (pp. 1)  7.1 For wooden surfaces  6.9 Vall-hung cabinets, 20mm thick (pp. 1)  7.1 For wooden surfaces  6.9 Vall-hung cabinets, 20mm thick (pp. 1)  7.1 For wooden surfaces  6.9 Vall-hung cabinets, 20mm thick (pp. 1)  7.1 For wooden surfaces  6.9 Vall-hung cabinets, 20mm thick (pp. 1)  7.1 For wooden surfaces  6.9 Vall-hung cabinets, 20mm thick (pp. 1)  7.1 For wooden surfaces  6.9 Vall-hung cabinets, 20mm thick (pp. 1)	Item No.	Description of Work or Materials	Work to Be Done	Ref	Unit	Estimated Quantity	Unit Price in Pesos (Words and Figures)	Total Amount (In Figures)
3" (75mm) ø uPVC pipe series 1000 downspout including joint fittings, solvents and brackets  5.10 Roof Drain: Removable stainless wire basket strainer  6.1 Utilities counter cabinets, 20mm thick (3/4") marine plywood including edging, framing, hardware, painting and accessories  6.2 Wall-hung cabinets, 20mm thick (3/4") marine plywood including edging, framing, hardware, painting and accessories  6.2 Wall-hung cabinets, 20mm thick (3/4") marine plywood including edging, framing, hardware, painting and accessories  6.2 For concrete surfaces  6.3 For fiberboard surfaces  6.4 For to NPC lot. 1 (P )  6.5 For concrete surfaces  6.6 Furnish and apply TS & Drawing TS		Of Individual	DO DONO				(110.00 0.10 1 194100)	(1111 (garoo)
Removable stainless wire basket strainer install TS & Drawing (P )  6.0 Carpentry Works  6.1 Utilities counter cabinets, 20mm thick furnish and accessories furnish and accessories  6.2 Wall-hung cabinets, 20mm thick furnish and accessories  6.3/4") marine plywood including edging, framing, hardware, painting and accessories  6.4 Wall-hung cabinets, 20mm thick furnish and accessories  6.5 Wall-hung cabinets, 20mm thick furnish and accessories  6.6 Wall-hung cabinets, 20mm thick furnish and accessories  6.7 Painting and Varnishing  6.8 Fer to NPC sq.m. 40.0	5.9	3" (75mm) ø uPVC pipe series 1000 downspout			li.m.	38	(P)	(P)
6.1 Utilities counter cabinets, 20mm thick (3/4") marine plywood including edging, framing, hardware, painting and accessories 6.2 Wall-hung cabinets, 20mm thick (3/4") marine plywood including edging, framing, hardware, painting and accessories 6.2 Wall-hung cabinets, 20mm thick (3/4") marine plywood including edging, framing, hardware, painting and accessories 7.0 Painting and Varnishing 7.1 For wooden surfaces  furnish and apply TS & Drawing  furnish and apply TS & Drawing  7.2 For concrete surfaces  furnish and apply TS & Drawing  furnish and Refer to NPC sq.m. 826.0  apply TS & Drawing  (P )  7.3 For fiberboard surfaces  furnish and Refer to NPC sq.m. 180.0	5.10		·		pcs.	10	(P)	(P
(3/4") marine plywood including edging, framing, hardware, painting and accessories  6.2 Wall-hung cabinets, 20mm thick (3/4") marine plywood including edging, framing, hardware, painting and accessories  7.0 Painting and Varnishing  7.1 For wooden surfaces furnish and apply TS & Drawing PP )  7.2 For concrete surfaces furnish and apply TS & Drawing PP )  7.3 For fiberboard surfaces furnish and apply TS & Drawing PP )  7.4 For fiberboard surfaces furnish and apply TS & Drawing PP )  7.5 For fiberboard surfaces furnish and apply TS & Drawing PP )	6.0	Carpentry Works						
(3/4") marine plywood including edging, framing, hardware, painting and accessories  7.0 Painting and Varnishing  7.1 For wooden surfaces  furnish and apply  TS & Drawing  Refer to NPC sq.m. 40.0  (P)  TS & Drawing  (P)  7.2 For concrete surfaces  furnish and apply  TS & Drawing  Refer to NPC sq.m. 826.0  apply  TS & Drawing  (P)  180.0	6.1	(3/4") marine plywood including edging, framing, hardware, painting and			lot.	1	)	(P)
7.1 For wooden surfaces    furnish and apply   Refer to NPC   sq.m.   40.0     (P   )     7.2 For concrete surfaces   furnish and apply   Refer to NPC   sq.m.   826.0   (P   )     7.3 For fiberboard surfaces   furnish and Refer to NPC   sq.m.   180.0	6.2	(3/4") marine plywood including edging, framing, hardware, painting and			lot.	1	(P)	(P)
7.2 For concrete surfaces furnish and apply TS & Drawing (P)  7.3 For fiberboard surfaces furnish and Refer to NPC sq.m. 826.0  (P)  (P)	7.0	Painting and Varnishing						
7.3 For fiberboard surfaces furnish and Refer to NPC sq.m. 180.0	7.1	For wooden surfaces			sq.m.	40.0	(P)	(P)
	7.2	For concrete surfaces			sq.m.	826.0	(P)	(P)
	7.3	For fiberboard surfaces			sq.m.	180.0	(P)	(P)
Note: The total amount shall be inclusive of Mark-Up (OCM and Profit) and VAT	Note:	The total amount shall be inclusive of Mark-Up (OCM and Profit) and VAT						
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#### **ARCHITECTURAL WORKS**

Item No.	Description of Work or Materials	Work to Be Done	Ref	Unit	Estimated Quantity	Unit Price in Pesos (Words and Figures)	Total Amount (In Figures)
8.0	Miscellaneous Items						
8.1	Waterproofing Membrane: 5 layers of bitumen with polyethylene reinforcement sheeting.	furnish, deliver & install	Refer to NPC TS & Drawing	sq.m.	129	(P)	(P)
8.2	Counter top splash board 300mm x 300mm ceramic tiles for utility area including grout, mortar and tile adhesive on 40mm thick R.C. counter slab	furnish and install	Refer to NPC TS & Drawing	sq.m.	2.0	(P)	(P)
8.3	Floor drain 100mmx100mm (4"x4") stainless steel with stainless wire strainer	furnish and install	Refer to NPC TS & Drawing	set	2	(P)	(P)
8.4	Ready made Plastic Medicine Cabinet Asian made, with mirror (100mm x 400mm x 500mm)	furnish and install	Refer to NPC TS & Drawing	set	1	(P)	(P)
8.5	Vapor barrier, Polyethylene, Grade 6	furnish and install	Refer to NPC TS & Drawing	sq.m.	120.0	(P)	(P)
8.6	Soil poisoning, authorized anti-termite liquid concentrate	furnish and apply	Refer to NPC TS & Drawing	sq.m.	294.0	(P)	(P)
8.7	Wood preservative	furnish and apply	Refer to NPC TS & Drawing	sq.m.	4.0	(P)	(P)

Note: The total amount shall be inclusive of Mark-Up (OCM and Profit) and VAT



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#### **ARCHITECTURAL WORKS**

Item No.	Description of Work or Materials	Work to Be Done	Ref	Unit	Estimated Quantity	Unit Price in Pesos (Words and Figures)	Total Amount (In Figures)
II.	GUARDHOUSE						
1.0	Wall System and Finishes						
1.1	150mm thick (6") CHB Wall including mortar, grout with 10mm Ø Rebar @ 0.60m vertical & horizontal spacing	furnish & lay	Refer to NPC TS & Drawing	sq.m.	15.9	(P)	(P)
1.2	Plain cement plaster finish (For Exterior and Interior Walls)	furnish & apply	Refer to NPC	sq.m.	29.2	<del></del>	
2.0	Floor Finishes						
2.1	Plain cement plaster floor finish.	furnish & apply	Refer to NPC TS & Drawing	sq.m.	2.9	(P)	(P)
3.0	Fenestration						
3.1	D-1: (800mmx2100mm) Flush type wooden door marine plywoo both sides, 2"x4" hard wood jamb, including heavy duty loose pin hinges, door knob/lockset weather proof and painting.	furnish & install	Refer to NPC TS & Drawing	set	1	(P)	(P)
3.2	W-1: (1100mmx1200mm) glass and alum, sliding window 2 x 4" heavy gage extruded aluminum frame anodized finish with 6 mm thick clear glass	furnish & install	Refer to NPC TS & Drawing	sets	2	(P)	(P)
3.3	W-2: (600mmx1100mm) glass and alum. fix window heavy gage extruded 2 x 4" anodized aluminum frame with 6 mm thick clear glass	furnish & install	Refer to NPC TS & Drawing	set	1	(P)	(P)
Note:	The total amount shall be inclusive of Mark-Up (OCM and Profit) and VAT						
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#### **ARCHITECTURAL WORKS**

Item No.	Description of Work or Materials	Work to Be Done	Ref	Unit	Estimated Quantity	Unit Price in Pesos (Words and Figures)	Total Amount (In Figures)
6.0	Painting and Varnishing						
6.1	All concrete surfaces	furnish & apply	Refer to NPC TS & Drawing	sq.m.	30.8	(P)	(P)
7.0	Miscellaneous						
7.1	Soil poisoning, authorized anti-termite liquid concentrate.	furnish & apply	Refer to NPC TS & Drawing	sq.m.	5.0	)	(P)
III.	PUMPHOUSE						
1.0	Wall System and Finishes						
1.1	150mm thick CHB wall including reinforcements	furnish & lay	Refer to NPC TS & Drawing	sq.m.	14		(P)
1.2	Pre-cast Concrete Louvers (300mm x 300mm)	furnish & lay	Refer to NPC TS & Drawing	pcs.	20.00	(P)	(P)
1.3	Plain cement plaster finish	furnish & apply	Refer to NPC TS & Drawing	sq.m.	20	(P)	(P)
2.0	Floor Finishes						
2.1	Plain concrete floor finish	furnish & apply	Refer to NPC TS & Drawing	sq.m.	2.7	(P)	(P)
Note:	The total amount shall be inclusive of Mark-Up (OCM and Profit) and VAT						
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#### **ARCHITECTURAL WORKS**

Item	Description of Work	Work to	Ref	Unit	Estimated	Unit Price in Pesos	Total Amount
No.	or Materials	Be Done	Itel	Onit	Quantity	(Words and Figures)	(In Figures)
3.0	Fenestration						
3.1	Flush Door Type Marine Plywood: (0.90m x 2.10m) with Door Jamb, including lockset, accessories and painting.	furnish & install	Refer to NPC TS & Drawing	set	1	(P)	(P)
4.0	Painting and Varnishing						
4.1	All concrete surfaces	furnish & apply	Refer to NPC TS & Drawing	sq.m.	9	(P)	(P)
5.0	Miscellaneous						
5.1	Soil poisoning; authorized anti-termite liquid concentrate.	furnish & apply	Refer to NPC TS & Drawing	sq.m.	5.0	(P)	(P)
Note:	The total amount shall be inclusive of Mark-Up (OCM and Profit) and VAT						
\$	SUB-TOTAL AMOUNT OF BID (ARCHITECTURAL WORKS	)				(P)	(P)

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SECTION VII - BILL OF QUANTITIES

SUPPLY, DELIVERY, CONSTRUCTION, INSTALLATION, TESTING AND COMMISSIONING OF 10MVA MASBATE (MALINTA) SUBSTATION

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CIVIL WORKS

		CIV	IL WORKS				
Item No.	Description of Work or Materials	Work to Be Done	Ref	Unit	Estimated Quantity	Unit Price in Pesos (Words and Figures)	Total Amount (In Figures)
l.	SITE DEVELOPMENT						
1.0	Earthworks						
1.1	Clearing and Grubbing (including cutting of trees)	cut, stockpile & dispose	Refer to NPC TS & Drawing	lot.	1	(P)	(P)
1.2	Grading Excavation	excavate, reuse & dispose	Refer to NPC TS & Drawing	cu.m.	8733	(P)	(P)
1.3	Grading Fill	spread & compact	Refer to NPC TS & Drawing	cu.m.	2510	(P)	(P)
2.0	Parking (including entrance pavement and concrete walkway)						
2.1	Aggregate Sub-Base 100mm thick for parking	furnish, place, spread & compact	Refer to NPC TS & Drawing	cu.m.	23.3	(P)	(P)
2.2	Concrete Pavement (20.70 MPa) 125mm thick	furnish & construct	Refer to NPC TS & Drawing	cu.m.	29	(P)	(P)
2.3	Rebar (Grade 40)	furnish & istall	Refer to NPC TS & Drawing	kg	867	(P )	(P )
3.0	Roadways		10 & Drawing			/	
3.1	Aggregate Sub-Base 150mm thick for pavement, curb & gutter, sidewalk (including grading works)	furnish, place, spread & compact	Refer to NPC TS & Drawing	cu.m.	167	(P)	(P)
3.2	Concrete Pavement (20.70 MPa) (including dowels, joint fillers, etc.)	furnish & construct	Refer to NPC TS & Drawing	cu.m.	128	(P)	(P)
Note:	The total amount shall be inclusive of Mark-Up (OCM and Profit) and VAT	•					

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#### **CIVIL WORKS**

Item No.	Description of Work or Materials	Work to Be Done	Ref	Unit	Estimated Quantity	Unit Price in Pesos (Words and Figures)	Total Amount (in Figures)
		3030113				(troite and rigation)	(1111190100)
3.3	Curbs, Gutters and Sidewalks (20.70 MPa) including rebars	furnish & construct	Refer to NPC TS & Drawing	cu.m.	30	(P)	(P)
4.0	Drainage System and Appurtenances						
4.1	0.10 Ø PVC Pipes for downspouts and Drainage Pipe	furnish & install	Refer to NPC TS & Drawing	li.m.	89	(P)	(P)
4.2	0.15 Ø Perforated PVC Pipes	furnish & install	Refer to NPC TS & Drawing	łi.m.	268	(P)	(P)
4.3	0.15 Ø PVC Pipe from Cable Trench	furnish & install	Refer to NPC TS & Drawing	li.m.	58	(P)	(P)
4.4	0.375 Ø Reinforced Concrete Drainage Pipe (RCDP)	furnish & install	Refer to NPC TS & Drawing	li.m.	182	(P)	(P)
4.5	Open RC Canal	furnish & construct	Refer to NPC TS & Drawing	li.m,	136	(P)	(P)
4.6	Street Inlet Catch Basin	furnish & construct	Refer to NPC TS & Drawing	рс.	11	(P)	(P)
4.7	Intersecting PVC Pipes Catch Basin	furnish & construct	Refer to NPC TS & Drawing	pc.	7	(P)	(P)
4.8	Catch Basin for Downspouts (@ Contro! House)	furnish & construct	Refer to NPC TS & Drawing	pc.	10	(P)	(P)
4.9	Septic Tank	furnish & construct	Refer to NPC TS & Drawing	рс.	1	(P)	(P)
Note:	The total amount shall be inclusive of Mark-Up (OCM and Profit) and VAT						
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#### **CIVIL WORKS**

Item No.	Description of Work or Materials	Work to Be Done	Ref	Unit	Estimated Quantity	Unit Price in Pesos (Words and Figures)	Total Amount (In Figures)
4.10	Manhole	furnish & construct	Refer to NPC TS & Drawing	pc.	1		(P )
5.0	Interlink Wire Perimeter Fence		15 & Drawing			(P)	(P)
5.1	Interlink Wire Perimeter Fence (including main gate, zocalo wall and foundations)	furnish, fabricate & install	Refer to NPC TS & Drawing	li.m.	216	(P)	(P)
II.	SWITCHYARD						
1.0	Foundations for Equipment and Gantry Structures						
1.1	69 KV Gantry Structures	design, furnish, & construct	Refer to NPC TS & Drawing	lot	1	(P)	(P)
1.2	13.8 KV Gantry Structures	design, furnish, & construct	Refer to NPC TS & Drawing	lot	1	(P)	(P)
1.3	Power Transformer	design, furnish, & construct	Refer to NPC TS & Drawing	lot	1	(P)	(P)
1.4	Power Circuit Breakers	design, furnish, & construct	Refer to NPC TS & Drawing	lot	1	(P)	(P)
1.5	Disconnect Switches	design, furnish, & construct	Refer to NPC TS & Drawing	lot	1	(P)	(P)
1,6	Metal Clad Switchgear	design, furnish, & construct	Refer to NPC TS & Drawing	lot	1	(P)	(P)
1.7	Surge Arresters	design, furnish, & construct	Refer to NPC TS & Drawing	lot	1	(P)	(P)
Note:	The total amount shall be inclusive of Mark-Up (OCM and Profit) and VAT						
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#### SECTION VII - BILL OF QUANTITIES

#### **CIVIL WORKS**

Item No.	Description of Work or Materials	Work to Be Done	Ref	Unit	Estimated Quantity	Unit Price in Pesos (Words and Figures)	Total Amount (In Figures)
1.8	Current Transformers	design, furnish, & construct	Refer to NPC TS & Drawing	lot	1	(P)	(P)
1.9	Voltage Transformers	design, furnish, & construct	Refer to NPC TS & Drawing	lot	1	(P)	(P)
1.10	Bus Supports	design, furnish, & construct	Refer to NPC TS & Drawing	lot	1	(P)	(P)
1.11	Outdoor Metering	design, furnish, & construct	Refer to NPC	lot	1	(P)	(P )
2.0	Cable Trench	a construct	TS & Drawing			(\(\tilde{\Pi})\)	
2.1	CT-1	furnish & construct	Refer to NPC TS & Drawing	li.m.	17	(P)	(P)
2.2	CT-2	fumish & construct	Refer to NPC TS & Drawing	li.m.	140	(P)	(P)
2.4	СТ-3	furnish & construct	Refer to NPC TS & Drawing	li.m.	2.7	(P)	(P)
3.0	Seclusion Fence						
3.1	Seclusion fence (including foundation, zocalo wall and gate)	furnish & construct	Refer to NPC TS & Drawing	li.m.	63	(P)	(P)
4.0	Gravel Surfacing						
4.1	150mm thick Gravel Surfacing	furnish, place, spread & compact	Refer to NPC TS & Drawing	cu.m.	407	(P)	(P)

Note: The total amount shall be inclusive of Mark-Up (OCM and Profit) and VAT

Name of Firm

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SECTION VII - BILL OF QUANTITIES

SUPPLY, DELIVERY, CONSTRUCTION, INSTALLATION, TESTING AND COMMISSIONING OF 10MVA MASBATE (MALINTA) SUBSTATION

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#### **CIVIL WORKS**

			L 11011110		l =		
ltem No.	Description of Work or Materials	Work to Be Done	Ref	Unit	Estimated Quantity	Unit Price in Pesos (Words and Figures)	Total Amount (in Figures)
81.	STRUCTURES						
1.0	Control House						
1.1	Structural Excavation	excavate, stockpile & dispose	Refer to NPC TS & Drawing	cu.m.	47	(P)	(P)
1.2	Structural Backfill	place, spread & compact	Refer to NPC TS & Drawing	cu.m.	79	(P)	(P)
1.3	Sand and Gravel Bedding	furnish, place, spread & compact	Refer to NPC TS & Drawing	cu.m.	4	(P)	(P)
1.4	Concrete (20.70 MPa at 28 days)	furnish, place & vibrate	Refer to NPC TS & Drawing	cu.m.	48	(P)	(P)
1.5	Rebar (Grade 40)	furnish, cut, bend, schedule & install	Refer to NPC TS & Drawing	kg.	7622	(P)	(P)
2.0	Guardhouse						
2.1	Structural Excavation	excavate, stockpile & dispose	Refer to NPC TS & Drawing	cu.m.	2.6	(P)	(P)
2.2	Structural Backfill	płace, spread & compact	Refer to NPC TS & Drawing	cu.m.	<b>2</b> .7	(P)	(P)
2.3	Sand and Gravel Bedding	furnish, place, spread & compact	Refer to NPC TS & Drawing	cu.m.	0.3	(P)	(P)

Note: The total amount shall be inclusive of Mark-Up (OCM and Profit) and VAT

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SECTION VII - BILL OF QUANTITIES

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### CIVIL WORKS

finomA latoT	Unit Price in Pesos	Estimated		0)))(0.14.7	Work to	Description of Work	mestl
(In Figures)	(Words and Figures)	Quantity	tinU	Ref	Be Done	or Materials	.oN
	·	8.2	.m.uɔ	Refer to NPC	furnish, place	Concrete (20.70 MPa at 28 days)	<b>4.</b> S
(	( <del></del>			TS & Drawing	8 Aribrate		
( <u>d)</u>	( ч)	8.298	кд.	Refer to NPC	fumish, cut, bend,	Rebar (Grade 40)	2.5
,				Bniwarid & ST	schedule & install	· -	
						Pumphouse	3.0
, 3,	. 3,	8.£	.m.nɔ	Refer to NPC	excavate, stockpile	Structural Excavation	1.6
(——— <u>a</u> )	( <del></del> 9)			PS & Drawing	əsodsib &		
( 4)	<u> </u>	2.2	cn.m.	Refer to NPC	place, spread	Structural Backfill	3.2
(	_ ( <del></del> a)			TS & Orawing	& compact		
( a)	<u> </u>	5.0	.m.uo	Refer to NPC	fumish, place,	Sand and Gravel Bedding	3.3
(	_ (- <del></del> 9)			PS & Drawing	spread & compact		
(	( <u>a</u> )	Z.5	.m.uo	Refer to NPC TS & Drawing	furnish, place & vibrate	Concrete (20.70 MPa at 28 days)	4.5
, <del></del> ,_ <del>_</del>	- ,—		-				
(	(q)	324.0	kд.	Refer to NPC TS & Drawing	furnish, cut, bend, schedule & install	Rebar (Grade 40)	3.5
				Supple 5 of		( a 2 a a a a a a a a a a a a a a a a a	•
						Elevated Water Storage Tank	<b>0</b> °¢
( d)	<del>\</del>	3.2	ຕາ ພາ	Refer to MPC	excavate, stockpile	Structural Excavation	じゃ
( <del></del> 9)	_ ( <del></del> a)			ES & Drawing	esodsip &		
(9)	(q)	9.1	cu.m.	Refer to MPC TS & Drawing	place, spread & compact	Structural Backfill	Z.4
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SECTION VII - BILL OF QUANTITIES

#### **CIVIL WORKS**

	CIVIL WORKS											
item No.	Description of Work or Materials	Work to Be Done	Ref	Unit	Estimated Quantity	Unit Price in Pesos (Words and Figures)	Total Amount (In Figures)					
4.3	Sand and Gravel Bedding	furnish, place, spread & compact	Refer to NPC TS & Drawing	cu.m.	0.1	(P)	(P)					
4.4	Concrete (20.70 MPa at 28 days)	furnish, place & vibrate	Refer to NPC TS & Drawing	cu.m.	1.3	(P)	(P)					
4.5	Rebar (Grade 40)	furnish, cut, bend, schedule & install	Refer to NPC TS & Drawing	kg.	150	(P)	(P)					
4.6	Structural Steel Structure - A36 hot dip galvanized (including stiffener plate, gusset plate, turn buckle, base plate, round bar, nuts, washers and bolts)	furnish, fabricate, assemble and install	Refer to NPC TS & Drawing	kg.	746	(P)	(P)					
4.7	G.I. Pipe Ladder (including ladder guard)	furnish, fabricate assemble and install	Refer to NPC TS & Drawing	kg.	173	(P)	(P)					
5.0	Flag Pole & Perimeter Lighting Foundation											
5.1	Flag Pole (foundation and pole)	fumish & construct	Refer to NPC TS & Drawing	lot	1.0	(P)	(P)					
5.2	Perimeter Lighting - 9 pcs (foundation)	furnish & construct	Refer to NPC TS & Drawing	lot	1.0	(P)	(P)					
6.1	Grouted Riprap (including sand and gravel filter and weep holes)	fumish & construct	Refer to NPC TS & Drawing	cu.m.	451	(P)	(P)					
Note:	The total amount shall be inclusive of Mark-Up (OCM and Profit) and VAT											
	SUB-TOTAL AMOUNT OF BID (CIVIL WORKS)					(P)	(P)					
	Name of Firm	Name and Signature o	f Authorized Rep	resentati	ive		 Designation					



ltem No.	Description of Work or Materials	Work to be Done	Reference	Unit	Estimated Quantity	Unit Price in Pesos (In Words & Figures)	Total Amount (In Figures)
	SUBSTATION EQUIPMENT						
1.0	Existing 10MVA, 69/13.8/13.8kV, 60Hz, 3-phase, Three Power tranformer, YNd1yn0, ONAN	winding					
1.0a	Conduct Transformer Insulation Resistance Test, Winding Resistance test, Oil Test, Ratio Test, Capacitance & Dissipation (Power) Factor Test prior to dismantling of the transformer.	test	TS, TDS & Dwgs	lot	1	(P )	P
1.0b	Dismantling and Undressing of 10MVA Power Transformer accessories, Detanking and transfer of the existing transformer oll in a clean drum container	dismantle, undress & detank	TS, TDS & Dwgs	set	1	(P )	P
1.0c	Crating of all transformer accessories.	crate	TS, TDS & Dwgs	lot	1	(P	P
1.0d	Hauling of 10MVA Power Transformer and its accessories from Mobo S/S to proposed location of Masbate (Malinta) S/S.	haul	TS, TDS & Dwgs	lot	1	(P )	P
1.0e	Supply Power Transformer Mineral Insulating Oil  "PCB free" in accordance with specifications and technical data sheet.	supply and fill	TS, TDS & Dwgs	kgs	7800	(P )	P
1.0f	Replace gaskets of the secondary housing of the current transformer, radiator valve and oil piping flanges.	supply & install	TS, TDS & Dwgs	set	1	(P )	P
1.0g	Replace rubber bushing for secondary terminal bushing;	supply & install	TS, TDS & Dwgs	set	1	(P )	P
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Item No.	Description of Work or Materials	Work to be Done	Reference	Unit	Estimated Quantity	Unit Price in Pesos (In Words & Figures)	Total Amount (In Figures)
1.0h	Calibration of the mechanical protection of the transformer (winding temperature, oil temperature, oil level indicator, rapid pressure, pressure relay, and buchholz	calibrate relay)	TS, TDS & Dwgs	lot	1	(P )	P
1.0i	Installation, Testing and Commissioning of 10MVA Power Transformer and its accessories to Masbate S/S.	install, test & commissioning	TS, TDS & Dwgs	set	1	(P )	P
2.0	69kV Power Circuit Breaker, 600A, 20kA, 3 pole operation, complete with the required accessories, spare parts/tools and supporting structures in accordance with the drawings, Specifications and Technical Data Sheets	supply, install & test	TS, TDS & Dwgs	sets	4	(P )	P
3.0	69kV Disconnect Switch with Earthing Switch, 600A continuous, 20kA, suitable for 3-Pole operation, complete with the required accessories, spare parts/tools and supporting structures in accordance with the drawings, Specifications and Technical Data Sheets.	supply, install & test	TS, TDS & Dwgs	sets	3	(P )	P
4.0	69kV Disconnect Switch without Earthing Switch, 600A, continuous, 20kA, suitable for 3-Pole operation, complete with the required accessories, spare parts/tools and supporting structures in accordance with the drawings, Specifications and Technical Data Sheets.	supply, install & test	TS, TDS & Dwgs	sets	9	(P )	P
5.0	Main Control Switchboard, 69/13.8kV, indoor type, complete with all the necessary devices and accessories, spare parts/tools and test equipment for the proper operation and maintenance of the equipment in accordance with the Drawings, Specifications and Technical Data Sheets.	supply, install & test	TS, TDS & Dwgs	set	1	(P)	P
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item No.	Description of Work or Materials	Work to be Done	Reference	Unit	Estimated Quantity	Unit Price in Pesos (In Words & Figures)	Total Amount (In Figures)
6.0	15kV Metal-clad Switchgear, outdoor type, connected on the wye side of the transformer, complete with the required equipment and appurtenances (i.e. 230VAC Main Distribution Board, surge arrester, circuit breaker, instrument transformers, relays, meters, instrumentation, termination kits, etc.) and all necessary devices and accessories including test equipment in accordance with the Specifications, drawings and Technical Data Sheets.	supply, install & test	TS, TDS & Dwgs	set	1	(P )	P
7.0	Station Service Transformer, 75kVA, 3 Phase, 60Hz, 13.8kV/230VAC mounted inside the Metal-clad Switchgear complete with the required accessories and devices including spare parts/tools in accordance with the Drawings, Specifications and Technical Data Sheets.	supply, install & test	TS, TDS & Dwgs	set	1	(P )	P
8.0	60kV Surge Arrester, outdoor type, complete with the required accessories, spare parts/tools and supporting structures in accordance with the drawings, Specifications and Technical Data Sheets.	supply, install & test	TS, TDS & Dwgs	sets	12	(P )	P
9.0	12kV Surge Arrester, outdoor type, complete with the required accessories, spare parts/tools and supporting structures in accordance with the drawings, Specifications and Technical Data Sheets.	supply, instail & test	TS, TDS & Dwgs	sets	9	(P )	P
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Item No.	Description of Work or Materials	Work to be Done	Reference	Unit	Estimated Quantity	Unit Price in Pesos (In Words & Figures)	Total Amount (In Figures)
10.0	69kV Current Transformer, outdoor type, 600:1A, multi-ratio with 0.3 accuracy class, four core complete with the required accessories, spare parts/tools and supporting structures including anchor bolts and mounting bolts in accordance with the drawings, Specifications and Technical Data Sheets.	supply, install & test	TS, TDS & Dwgs	sets	24	(P )	P
11.0	69kV Voltage Transformer, outdoor type, with 0.3 accuracy class complete with the required accessories spare parts/tools and supporting structures including anchor bolts and mounting bolts in accordance with the drawings, Specifications and Technical Data Sheets.	supply, install & test	TS, TDS & Dwgs	sets	12	(P)	P
12.0	69kV Current Transformer for Revenue Meter, outdoor type, 600:1A, multi-ratio with 0.3 accuracy class, two core complete with the required accessories, spare parts/tools and supporting structures including anchor bolts and mounting bolts in accordance with the drawings, Specifications and Technical Data Sheets.	supply, install & test	TS, TDS & Dwgs	sets	9	(P )	P
13.0	69kV Voltage Transformer for Revenue Meter, outdoor type, with 0.3 accuracy class complete with the required accessories spare parts/tools and supporting structures including anchor bolts and mounting bolts in accordance with the drawings, Specifications and Technical Data Sheets.	supply, install & test	TS, TDS & Dwgs	sets	9	(P)	Ρ
14.0	69kV Outdoor Metering Equipment complete with the required supporting structures, anchor bolts and accessories, composed of the ff.:  1. Billing Meter and its Cabinet	supply, install & test	TS, TDS & Dwgs	sets	3	(P )	P
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Item No.	Description of Work or Materials	Work to be Done	Reference	Unit	Estimated Quantity	Unit Price in Pesos (In Words & Figures)	Total Amount (In Figures)
15.0	13.8kV Outdoor Metering Equipment complete with the required supporting structures, anchor bolts and accessories, composed of the ff.:  1. Billing Meter and its Cabinet 2. Current Transformer, 13.8kV (3 units/set) 3. Voltage Transformer, 13.8kV (3 units/set)	supply, install & test	TS, TDS & Dwgs	sets	2	(P )	P
16.0	Steel (Gantry) Structures, 69kV & 13.8kV configuration, latice type, hot dipped galvanized, complete with all mounting bolts and accessories in accordance with the Drawings, Specifications and Technical Data Sheets.						
	a. 69kV Post	supply & install	TS, TDS & Dwgs	lot	1	(P )	P
	b. 69kV Beam	supply & install	TS, TDS & Dwgs	lot	1	(P)	P
	c. 13.8kV Post	supply & install	TS, TDS & Dwgs	lot	1	(P)	Р
	d. 13.8kV Beam	supply & install	TS, TDS & Dwgs	lot	1	(P )	P
17.0	AC and DC Auxiliary Switchboards, complete with the required devices and accessories including spare parts/ tools in accordance with the drawings, Specifications and Technical Data Sheets.	supply, instail & test	TS, TDS & Dwgs	lot	1	(P )	P
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Item No.	Description of Work or Materials	Work to be Done	Reference	Unit	Estimated Quantity	Unit Price in Pesos (In Words & Figures)	Total Amount (In Figures)
18.0	125VDC Battery Charger complete with all the necessary devices and accessories including spare parts/tools in accordance with the Drawings, Specifications and Technical Data Sheets.	supply, install & test	TS, TDS & Dwgs	set	1	(P .)	P
19.0	125VDC Battery Bank, complete with the required battery racks including spare parts/tools and accessories in accordance with the Drawings, Specifications and Technical Data Sheets.	supply, install & test	TS, TDS & Dwgs	set	1	(P )	P
20.0	69kV Line Protection System, indoor type, complete with protection module, auxiliary relays, fault locator and accessories, including spare parts/tools in accordance with the Drawings, Specifications and Technical Data Sheets.	supply, install & test	TS, TDS & Dwgs	sets	3	(P )	P
21.0	Transformer Protection System, indoor type, complete with protection module, auxiliary relays and accessories including spare parts/tools in accordance with the Drawings, Specifications and Technical Data Sheets.	supply, install & test	TS, TDS & Dwgs	set	1	(P )	Ρ
22.0	69kV Porcelain Station Post Insulator, outdoor type, with 350kV BIL complete with the required accessories spare parts/tools and supporting structures including anchor bolts and mounting bolts in accordance with the drawings.	supply, install & test	TS, TDS & Dwgs	sets	12	(P )	P
23.0	GENERAL EQUIPMENT AND ACCESSORIES Installation Materials consisting of bus conductors, support insulators, hardwares, fittings, connectors, clamps, phase markers, etc. in accordance with the drawings, Specifications and Technical Data Sheets.	supply, install & test	TS, TDS & Dwgs	lot	1	(P )	P
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ltem No.	Description of Work or Materials	Work to be Done	Reference	Unit	Estimated Quantity	Unit Price in Pesos (In Words & Figures)	Total Amount (In Figures)
24.0	Grounding System including grounding mat and rods exothermic connection, riser connection to steel structures, seclusion fence, switchyard eqpt. and interconnection to the control room in accordance with the drawings, Specifications and Technical Data Sheets.						
	<ul> <li>a. 100mm² SDCC tin annealed PVC sheated and insulated for down leads substation equipment through grounding mat.</li> </ul>	supply, install & test	TS, TDS & Dwgs	lot	1	(P )	P
	<ul> <li>b. 100mm² bare, Soft drawn copper conductor (SDCC), tin annealed.</li> </ul>	supply, install & test	TS, TDS & Dwgs	lot	1	(P )	P
	<ul> <li>60mm² bare, Soft drawn copper conductor (SDCC), tin annealed for perimeter fence, swinging gates and lighting post.</li> </ul>	supply, install & test	TS, TDS & Dwgs	lot	1	(P )	Ρ
	<ul> <li>d. Braided 60mm² bare, Soft drawn copper conductor, tin annealed for swinging gates.</li> </ul>	supply, install & test	TS, TDS & Dwgs	lot	1	(P )	P
	e. Copper clad ground rods, 19mm diameter x 3000mm in length.	supply, install & test	TS, TDS & Dwgs	pcs.	43	(P )	P
	<ul> <li>f. Thermoweld powder needed for making the diff. types of thermoweld joints.</li> </ul>	supply, install & test	TS, TDS & Dwgs	lot	1	(P )	P
	g. Test pit	supply, install & test	TS, TDS & Dwgs	sets	2	(P )	P
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Item No.	Description of Work or Materials	Work to be Done	Reference	Unit	Estimated Quantity	Unit Price in Pesos (In Words & Figures)	Total Amount (In Figures)
25.0	Power, Control and Instrument Cables in accordance with the drawings, Specifications and Technical Data Sheets.						
	1. Power Cables, 15 kV XLPE insulation						
	a.) 1c x 400 mm²	supply & install	TS, TDS & Dwgs	lot	1	(P )	P
	b.) 1c x 70 mm²	supply & install	TS, TDS & Dwgs	lot	1	(P )	P
	2. Power Cables, 600V THHN/THWN-2						
	a.) 1c x 14.0 mm²	supply & install	TS, TDS & Dwgs	lot	1	(P )	Ρ
	b.) 1c x 8.0 mm <sup>2</sup>	supply & install	TS, TDS & Dwgs	lot	1	(P )	P
	c.) 1c x 5.5 mm <sup>2</sup>	supply & install	TS, TDS & Dwgs	lot	1	(P _)	٩
	d.) 1c x 3.5 mm <sup>2</sup>	supply & install	TS, TDS & Dwgs	lot	1	(P )	P
	TC/PVC						
	a.) 2c x 6.0 mm <sup>2</sup>	supply & install	TS, TDS & Dwgs	lot	1	(P	P
	b.) 2c x 4.0 mm <sup>2</sup>	supply & install	TS, TDS & Dwgs	lot	1	(P )	P
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Item No.	Description of Work or Materials	Work to be Done	Reference	Unit	Estimated Quantity	Unit Price in Pesos (In Words & Figures)	Total Amount (In Figures)
	c.) 3c x 6.0 mm <sup>2</sup>	supply & install	TS, TDS & Dwgs	lot	1	(P )	P
	3. Control & Instrument Cables a.) 4c x 2.5 mm <sup>2</sup> (shielded)	supply & install	TS, TDS & Dwgs	lot	1	(P )	P
	b.) 4c x 4.0mm <sup>2</sup> (shielded)	suppty & install	TS, TDS & Dwgs	lot	1	(P )	P
	c.) 4c x 5.5 mm <sup>2</sup> (shielded)	supply & install	TS, TDS & Dwgs	lot	1	(P)	P
	d.) $5c \times 4.0 \text{ mm}^2$ (shielded)	supply & install	TS, TDS & Dwgs	lot	1	(P )	P
26.0	Lighting and Power System in accordance with the drawing, Technical Specifications and Technical Data Sheets composed of the following:						
	Indoor/Outdoor Lighting Fixtures     Fixture Type A	supply, install & test	TS, TDS & Dwgs	sets	12	(P )	P
	2. Fixture Type B	supply, install & test	TS, TDS & Dwgs	sets	4	(P )	P
	3. Fixture Type C	supply, instatl & test	TS, TDS & Dwgs	sets	2	(P )	P
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m o.	Description of Work or Materials	Work to be Done	Reference	Unit	Estimated Quantity	Unit Price in Pesos (In Words & Figures)	Total Amount (In Figures)
4, F	ixture Type D	supply, install & test	TS, TDS & Dwgs	sets	5	(P )	P
5. F	ixture Type I	supply, install & test	TS, TDS & Dwgs	sets	7	(P )	P
6. F	ixture Type F	suppły, install & test	TS, TDS & Dwgs	sets	6	(P	P
7. F	ixture Type K	supply, install & test	TS, TDS & Dwgs	sets	9	(P )	P
8. F	ixture Type M	supply, install & test	TS, TDS & Dwgs	sets	2	(P )	P
9. F	ixture Type O	supply, install & test	TS, TDS & Dwgs	sets	2	(P )	P
b. Out	ets and Switches						
	onvenience Outlet, Duplex, 250V, 15A ingle Phase grounding type	supply, install & test	TS, TDS & Dwgs	sets	13	(P )	. P
	onvenience Outlet, Duplex, 250V, 15A Veather Proof, 1-Phase grounding type	supply, install & test	TS, TDS & Dwgs	sets	8	(P )	P
	nclosed Safety Breaker, 25 A -Phase, grounding type, NEMA 3R	supply, install & test	TS, TDS & Dwgs	sets	2	(P )	P
	nclosed Safety Breaker, 30 A -Phase, grounding type, NEMA 3R	supply, install & test	TS, TDS & Dwgs	sets	2	(P )	P
Name of	Firm	Name and Signature o	of Authorized F	Represe	ntative		Designation'

ltem No.	Description of Work or Materials	Work to be Done	Reference	Unit	Estimated Quantity	Uпit Price in Pesos (In Words & Figures)	Total Amount (In Figures)
	<ol><li>Exhaust fan/Emergency Light outlet single receptacle, 250V, 1-Phase, 15A</li></ol>	supply, install & test	TS, TDS & Dwgs	sets	8	(P )	P
	6. Switch, duplex, one gang plate, 10A, 250 VAC	supply, install & test	TS, TDS & Dwgs	sets	4	(P )	Ρ
	7. Switch, single, one gang plate, 10A, 250 VAC	supply, install & test	TS, TDS & Dwgs	sets	8	(P )	P
	c. Enclosed Safety Breaker, 20 A, 230 VAC , 1-Phase	supply, install & test	TS, TDS & Dwgs	sets	1	(P )	P
	d. Enclosed Safety Breaker, 20 A, 230 VAC , 1-Phase, NEMA 3R	supply, install & test	TS, TDS & Dwgs	sets	1	(P )	P
	e. Lighting/Power Panel Board and Circuit Breakers 230 VAC, 3-Phase, 14 + 1 CB Main Breaker: 100AF/60AT, 3P, MCCB Branch Circuit: 2 - 50AF/40AT, 2P, MCB 2 - 50AF/25AT, 2P, MCB 9 - 50AF/20AT, 2P, MCB 2 - 50AF/15AT, 2P, MCB	supply & install	TS, TDS & Dwgs	set	1	(P )	Ρ
27.0	Conduit and Cable Tray System in accordance with the drawings, Technical Specifications and Technical Data Sheets composed of the following:						
	a. Conduit 1. 20 mm dia. uPVC	supply & install	TS, TDS & Dwgs	l.m.	630	(P )	Ρ
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#### **ELECTRICAL WORKS**

Item No.	Description of Work or Materials	Work to be Done	Reference	Unit	Estimated Quantity	Unit Price in Pesos (In Words & Figures)	Total Amount (In Figures)
	2. 25 mm dia. uPVC	supply & install	TS, TDS & Dwgs	l.m.	200	(P)	P
	3. 32 mm dia. uPVC	supply & install	TS, TDS & Dwgs	l.m.	25	(P)	P
	3. 50 mm dia. uPVC	supply & install	TS, TDS & Dwgs	l.m.	150	(P )	P
	5. 110 mm dia. uPVC	supply & install	TS, TDS & Dwgs	l.m.	30	(P )	Р
	6. Baxes, Fittings & Accessories	supply & install	TS, TDS & Dwgs	lot	1	(P )	P
b	. Cable Tray System 1. Cable Tray ,Straight Type (300 mm x 100 mm)	supply & install	TS, TDS & Dwgs	l.m.	180	(P )	P
	Cable Tray , Horizontal Tee Type     (300 mm x 100 mm)	supply & install	TS, TDS & Dwgs	pcs.	7	(P )	P
	3. Cable Tray , 90° Horizontal Elbow (300 mm x 100 mm)	supply & install	TS, TDS & Dwgs	pcs.	3	(P)	Ρ
	4. Complet Cable Tray Support	supply & install	TS, TDS & Dwgs	lot	1	(P )	P

Name and Signature of Authorized Representative

Designation'



Item No.	Description of Work or Materials	Work to be Done	Reference	Unit	Estimated Quantity	Unit Price in Pesos (In Words & Figures)	Total Amount (In Figures)
	VIDEO SURVEILLANCE SYSTEM (CCTV)						
28.0	Main Distribution Frame (Data Cabinet): Baked Enamel Perforated Door w/lock & keys, 42U(H), 600(W), 1200(D) Accessories: 3-fixed trays, 15-outet 3-prong PDU, exhaust fans, adjustable square-hole rail w/cage nuts & bolts,	supply, install & test	Dwgs	set	1	(P )	P
29.0	8-channel, Network Video Recorder (NVR), 2-1 x 8TB NAS hard drive, VGA, HDMI, USB interface Accessories: Mounting tray, 1U cable management	supply, install & test	Dwgs	unit	1	(P )	P
30.0	5MP dome type IP-camera (POE) Indoor with 4 x 4 WP -box	supply, install & test	Dwgs	sets	3	(P )	P
31.0	5MP bullet type IP-camera (POE) outdoor with 4 x 4 WP -box & pole-mount bracket	supply, install & test	Dwgs	sets	5	(P )	P
32.0	8-port gigabit POE managed switch with 2-1X10GBE tranceiver uplink port	supply, install & test	Dwgs	set	1	(P)	P
33.0	3kVA uninterruptible Power Supply (UPS), online double conversion. Accessories: rack-mount bracket	supply, install & test	Dwgs	unit	1	(P )	P
34.0	Cat6 STP (Shielded Twisted Pair) Cable	supply, install & test	Dwgs	lot	1	(P )	P
35.0	42-inch LED monitor display VGA/HDMI interface Accessories: Wall-mount bracket, 15-meter HDMI cable	supply, install & test	Dwgs	unit	1	(P)	Р
	Name of Firm						 Designation'
,	Name of Film	Name and Signature o	t Authorized F	keprese	ntative		2001911011011

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Item No.	Description of Work or Materials	Work to be Done	Reference	Unit	Estimated Quantity	Unit Price in Pesos (In Words & Figures)	Total Amount (In Figures)
	VOICE AND DATA SYSTEM (TELEPHONE AND LAN)						
36.0	3-trunkline x 8-hybrid local lines IP-PABX, Accessories: Mounting tray, AC power supply, 2-1 x 12VDC 200Ah battery with DC cable, 24-THX digital phone, 1-1 x 8-SLT analog telephone, 1U cable management, programming as per NPC dialing plan.	supply, install & test	Dwgs	lot	1	(P )	P
37.0	24-port gigabit manage switch, 2-SFP uplink port, 220VAC	supply, instatl & test	Dwgs	unit	1	(P )	P
38.0	Krone LSA disconnect module with backplate Accessories: Mounting bracket	supply, instail & test	Dwgs	unit	1	(P )	Ρ
39.0	2-port faceplate with shutter for voice and data Input/Output (I/O)	supply, install & test	Dwgs	unit	1	(P )	P
40.0	RJ-45 voice information outlet (I/O), 110 punch-down	supply, install & test	Dwgs	unit	8	(P)	P
41.0	RJ-45 data information outlet (I/O), 110 punch-down	supply, install & test	Dwgs	unit	4	(P)	P
42.0	IP-66 steel floor standing telephone box 300(H) x 250(W) x 150(D)	supply, install & test	Dwgs	unit	1	(P)	P
43.0	Cat5e STP (shielded twisted pair) cable	supply, install & test	Dwgs	lot	1	(P )	P
44.0	RJ-45 unshielded jack	supply, install & test	Dwgs	pcs.	40	(P )	P
-1	Name of Firm	Name and Signature	of Authorized F	Represe	entative		Designation'

łtem No.	Description of Work or Materials	Work to be Done	Reference	Unit	Estimated Quantity	Unit Price in Pesos (In Words & Figures)	Total Amount (In Figures)		
45.0	Telephone flat cable-black (100m/roll)	supply, install & test	Dwgs	lot	1	(P )	P		
46.0	RJ-11 unshielded jack	supply, install & test	Dwgs	pcs.	20	(P )	Ρ		
	HUMAN MACHINE INTERFACE, MONITORING AND CONTROL								
47.0	Security gateway (firewall) small-form factor 3-network interface, EIA-232/EIA-485 serial ports, IRIG-B (I/O) time-synch, AC/DC power supply. Accessories: Mounting tray, 1U cable management	supply, install & test	Dwgs	set	1	(P )	Ρ		
48.0	Satellite-synchronized clock, large LED display EIA-232 serial port, IRIG-B (I/O), AC/DC power supply	supply, install & test	Dwgs	unit	1	(P )	P		
49.0	Real-time automation controller, Linux-base 533Mhz 1024MB RAM 2GB storage, ethernet & serial ports, DNP3 Serial, DNP3 LAN/WAN, Modbus RTU & TCP IEEE C37.118, IEC 61850 supported protocols IRIG-B (I/O), AC/DC power supply. Accessories RTAC software, and 1U cable management	supply, install & test	Dwgs	set	1	(P )	P		
50.0	24-port unmanaged ethernet switch, interface: 4-1 x Gbe ethernet copper, 16-1 x 10/100MBps, and 4-1 x SFP ports, redundant AC & DC power supply Accessories: 1U cable management	supply, install & test	Dwgs	units	2	(P )	Ρ		
51.0	Network printer, monochrome, 220VAC	supply, install & test	Dwgs	unit	1	(P)	Ρ		
1	Name of Firm	Name and Signature o	f Authorized F	Represe	ntative		Designation'		

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item No.	Description of Work or Materials	Work to be Done	Reference	Unit	Estimated Quantity	Unit Price in Pesos (In Words & Figures)	Total Amount (In Figures)
52.0	Local control center (operator): Accessories; 3-1 x 27-inch LED monitor display, RTAC-software for workstation, and keyboard & mouse.	supply, install & test	Dwgs	set	1		Р
53.0	Cat5e FTP (foil twisted pair) cable	supply, install & test	Dwgs	lot	1	(P)	P
54.0	RJ-45 metal-shielded jack	supply, install & test	Dwgs	pcs.	50	(P )	P
55.0	TWO-WAY RADIO COMMUNICATION  Two-way Radio Communication System, antenna mast with concrete foundation, cables, PTT microphone, and power supply, in accordance with the specifications and Technical Data Sheets						
	a Base Station, 136~174Mhz, 45W RF output, analog/digital sensitivity 0.3uV/.0.22uV, AMBE+21M digital vocoder, OTA programming, dual capacity, IP-54, external speaker, MIL-STD, FCC & ICC Standard cw/ DC power supply	supply, install & test	Dwgs	set	1	(P )_	P
	b Base Antenna, omni-directional fiberglass, 3.8dB gain, 144~174MHz, 200W max. power at 50-ohm c/w RG-8 high-grade coaxial cable, surge protector, and PL-259	supply, install & test	Dwgs	unit	1	(P )	P
	c 60-foot antenna mast, painted as per CAA standard with climbing steps, support accessories, and lightning arrester and ground cable.	supply, install & test	Dwgs	set	1	(P )	۴
1	Name of Firm	Name and Signature o	f Authorized F	Represe	ntative		Designation'

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Item No.	Description of Work or Materials	Work to be Done	Reference	Unit	Estimated Quantity	Unit Price in Pesos (In Words & Figures)	Total Amount (In Figures)
	Mobile Station, 136~174Mhz, 45W RF output, analog/digital sensitivity 0.3uV/0.22uV, AMBE+2TM digital vocoder, OTA programming, dual capacity, IP-54, MIL-STD, FCC & ICC Standard	supply, install & test	Dwgs	units	2	(P )_	P
	e Mobile Antenna, omni-directional 5/8-wave whip with PO/SO-239 magnetic-base mount, 200W max. power at 50-ohm c/w RG-58 high-grade coaxial cable, and PL- 259 connectors	supply, install & test	Dwgs	sets	2	(P )	P
	f Portable Station, LKP display, 5W RF output, analog/digital sensitivity 0.16uV/0.14uV, AMBE+2TM digital vocoder, IP67 rating and MIL-STD specs., spare lithium-ION battery pack with battery charger.	supply, install & test	Dwgs	sets	4	(P )	P
2	Programming (As per NPC licensed radio frequency), VSWR test, NTC licensing and assistance fee for the two-way radio communication system  EXPENSES FOR NPC PERSONNEL IN WITNESSING TO		Dwgs	lot	1	(P )	Ρ
	ACCEPTANCE TEST OF EQUIPMENT AT MANUFACTU	RERS PREMISES					
56.0	Factory Acceptance Test of 69kV Power Circuit Breaker to be witnessed by three(3) NPC representative in accordance with the specifications and technical data sheets at manufacturer's premises	test	EW-1.6.3.3, TS & TDS	lot	1	(P )	Ρ
57.0	Factory Acceptance Test of 15kV Metal-Clad Switchgear to be witnessed by three(3) NPC representative in accordance with the specifications and technical data sheets at manufacturer's premises	test	EW-1.6.3.3, TS & TDS	lot	1	(P )	P
<del></del> 1	Name of Firm	Name and Signature o	of Authorized F	Represe	ntative		Designation'



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Item No.	Description of Work or Materials	Work to be Done	Reference	Unit	Estimated Quantity	Unit Price in Pesos (In Words & Figures)	Total Amount (In Figures)
58.0	Factory Acceptance Test of 69kV Line Protection System to be witnessed by three(3) NPC representative in accordance with the specifications and technical data sheets at manufacturer's premises	test	EW-1.6.3.3, TS & TDS	lot	1	(P)	P
59.0	Factory Acceptance Test of 69kV Substation Protection System to be witnessed by three(3) NPC representative in accordance with the specifications and technical data sheets at manufacturer's premises	test	EW-1.6.3.3, TS & TDS	lot	1	(P)	P
	TOTAL (ELECTRICAL WORKS)					(P )	P

Name of Firm	Name and Signature of Authorized Representative	Designation'



SUPPLY, DELIVERY, CONSTRUCTION, INSTALLATION, TESTING AND COMMISSIONING OF 10MVA MASBATE (MALINTA) SUBSTATION LuzP23Z1636Sce

BILL OF QUANTITIES

ltem No.	Description of Work or Materials	Work to be Done	Ref. Clause	Unit	Estimated Quantity	Unit Price in Pesos (Words and Figures)	Total Amount
1.0	DOMESTIC WATER SUPPLY SYSTEM		MW-4.0				
1.1	Water Storage and Pumping System						
1.1.1	Deep Well Drilling, Development and Disinfection, 20 m deep, complete with 50 mm Ø casing and 32 mm Ø suction pipe conforming to ASTM A 53, Gr. A, Sch. 40 hot-dip galvanized including Well Drilling permit and other accessories as described in the technical specifications and as shown on the drawings	Drilling, Well Development & Disinfection and securing permit		Lot	1	(P)	۶
1.1.2	Convertible Jet Pump, 2.6m³/h (11.5 gpm) minimum capacity at 35 meters head, 230V, 1phase, 60hz with 25mm Ø hot dip galvanized steel suction pipe conforming to ASTM A53 Grade A, Schedule 40, welded or seamless complete with power cable, instruments & controls, control panel, and other accessories as described in the technical specifications.	Supply, Install and Test		Set	1	(P)	Ρ
1.1.3	Elevated Water Storage tank, 900 liters (237gal.) capacity, triple layer polyethylene, cylindrical flat bottom, complete with nozzles/manhote, inlet and outlet nozzles, supports, overflow and drain, nozzles with pipes.	Supply, Install and Test		Set	1	(P)	Ρ
1.1.4	Level Switch, Stainless Steel chamber and float two (2) level set points, field adjustable, designed for top mounting	Supply, Install and Test		Set	1	(P)	٩
1.1.5	Gate Valve, 32mm $\emptyset$ , cast bronze, rising stem, screwed ends, Class 150	Supply, Install and Test		Set	1	(2)	₽₽
1.1.6	Gate Valve, 25mm Ø, cast bronze, rising stem, screwed ends, Class 150	Supply, Install and Test		Set	1	(P)	P
1.1.7	Check Valve, 25mmØ, Swing type, cast bronze, screwed ends, Class 150	Supply, Install and Test		Set	1	(P)	Ρ
	Name of Firm	Name and Signa	ture of Autho	orized Repr	esentative	- Designation	n



BILL OF QUANTITIES

SUPPLY, DELIVERY, CONSTRUCTION, INSTALLATION, TESTING AND COMMISSIONING OF 10MVA MASBATE (MALINTA) SUBSTATION

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			Ref.		Estimated	Unit Price in Pesos (Words and	
Item No.	Description of Work or Materials	Work to be Done	Clause	Unit	Quantity	Figures)	Total Amount
No.	<u> </u>	·	018036		- Guaranty	1 (5,000)	
118	Water Pipe, 32mm O.D. (25mm N.D.), unplasticized PVC,	Supply, Excavate,		lm	12		
1.1.0	schedule 80 or class 150, associated fittings, pipe supports	Install, Test, &					
	and other accessories as described in the technical	Backfill				(P)	P
	specifications						
					•		
1.1.9	Pressure Gauge, 100mm Ø dial gauge, bourdon tube	Supply, Install		Sets	2		
	type, 0 - 3 kg/cm² scale range, equipped with isolation valve	and Test				(P	· R
1.1.10	Screen, 32mm Ø, stainless steel, 5mm slots fitted with (1) set of	Supply and Install		Set	1		
	Brass Foot Valve	****					
						(P)	΄ <b>2</b>
					1		
1.1.11	Spare parts for convertible jet pump for 1 year operation per	Supply & Delivery		Lot	'		•
	manufacturer's standard and as specified in the technical specifications.					(P )	· <u>p</u>
	specifications.						•
1.2	Domestic Water Supply Piping System						
121	Gate Valve, 25mm Ø, cast bronze, rising stem, screwed ends,	Supply, Install and		Sets	3		
1.6 (	Class 150	Test			_		•
1.2.2	Gate Valve, 20mmØ, cast bronze, rising stem, screwed ends,	Supply, Install and		Sets	1		•
	Class 150	Test					•
400	Meta-Bins 20mm O.D. (25mm N.D.) unplosticized 9\/C	Supply, Excavate,		ſm	18		
1.2.3	Water Pipe, 32mm O.D. (25mm N.D.), unplasticized PVC, schedule 80 or class 150, associated fittings, pipe supports	Install. Test. &		1121	,,,		-
	and other accessories as described in the technical	Backfill				( <del>S</del>	· p
	specifications						
	•						
1.2.4	Water Pipe, 25mm O.D. (20mm N.D.), unplasticized PVC.	Supply, Excavate,		îm.	18		-
	schedule 80 or class 150, associated fittings, pipe supports	Instali, Test, & Backfill				( <del>P</del> )	ъ
	and other accessories as described in the technical specifications	Dackiiii					
	specifications						
1,2.5	Water Pipe, 20mm O.D. (15mm N.D.), unplasticized PVC,	Supply, Excavate,		lm	6		
	schedule 80 or class 150, associated fittings, pipe supports	Install, Test, &					• _
	and other accessories as described in the technical	Backfill				(P)	` P
	specifications						
	Name of Firm	Name and Signa	ture of Autho	rized Repr	esentative	Designatio	<u></u>
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BILL OF QUANTITIES

SUPPLY, DELIVERY, CONSTRUCTION, INSTALLATION, TESTING AND COMMISSIONING OF 10MVA MASBATE (MALINTA) SUBSTATION

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Item No.	Description of Work or Materials	Work to be Done	Ref. Clause	Unit	Estimated Quantity	Unit Price in Pesos (Words and Figures)	Total Amount
1.2.6	Hose Bibb, 20mm Ø, bronze body, screwed ends, Class 150	Supply & Install		Sets	3		
1.2.7	Disinfection of elevated tank and domestic water piping system	Supply, perform & Test		lot	1		₽
2.0	AIR CONDITIONING & VENTILATION SYSTEM		MW-5.0				
2.1	Air-conditioning System						
2.1.1	Air conditioning units for Switchgears Room, 12,000 kJ/hr minimum cooling capacity, inverter split-type, wall mounted, inverter-type, complete with necessary mounting accessories and controls (infrared remote) and other necessary accessories as described in the technical specifications.	Supply, Install and Test		Sets	2	(P)	P
2.1.2	Air conditioning units for Control Room, 20,000 kJ/hr minimum cooling capacity, inverter split-type, wall mounted, inverter-type, complete with necessary mounting accessories and controls (infrared remote) and other necessary accessories as described in the technical specifications.	Supply, Install and Test		Sets	2	(P)	Ρ
2.2	Ventilating System						
2.2.1	Exhaust fan for Battery Room, 450m³/h, 240V, 1-phase, 60Hz, wall mounted, propeller type, direct driven, explosion proof, complete with automatic shutter, mounting accessories and controls	Supply, Install and Test		Set	1	(P)	P
2.2.2	Exhaust fans for Restroom, 150m³/h, 240V, 1-phase, 60Hz, wall mounted, propeller type, direct driven,	Supply, Install and Test		Set	1	(R	′ p
3.0	FIRE FIGHTING SYSTEM		MW-6.0				·
3,1	Portable Fire Extinguishers, HCFC or Halotron I, 7.1 kg (15 lbs), non-expiry, multi shots, wall hung type with bracket and mounting accessories and shall be in certified approved by the certifying body specified in Section VI, Part I, MW-6.1	Supply and Install		Sets	4	(P)	' P
	Name of Firm	Name and Signa	ature of Autho	orized Repr	esentative	Designatio	n .

SUPPLY, DELIVERY, CONSTRUCTION, INSTALLATION. TESTING AND COMMISSIONING OF 10MVA MASBATE (MALINTA) SUBSTATION

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#### BILL OF QUANTITIES

Item	1		Ref.		Estimated	Unit Price in Pesos (Words and	
No.	Description of Work or Materials	Work to be Done	Clause	Unit	Quantity	Figures)	Total Amount
4.0	LABELS OR TAGGING						
4.1	Tagging or Labels for Equipment, Valves, Piping, Instruments and its fixing accessories	Supply & Installation		Lot	1	(P )	D.
5.0	PAINTING					· · · · · · · · · · · · · · · · · · ·	<u>-</u>
5.1	Painting for tank support, domestic water equipment & piping, its associated valves, fittings, piping supports and other accessories including touch-up for factory painted equipment and accessories as described in the technical specifications	Supply & Apply		Lot	1	(P)	₽
	TOTAL MECHANICAL WORKS					(P)	Ρ
	Name of Firm	Name and Signal	ture of Autho	rized Repre	sentative	Designation	<u> </u>



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# SECTION VIII BIDDING FORMS



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NPCSF-INFR-15	-	Summary Sheets of Materials Prices, Labor Rates and Equipment Rental Rates

Standard Form No: NPCSF-INFR-01

#### Checklist of Technical & Financial Envelope Requirements for Bidders

## A. THE 1<sup>ST</sup> ENVELOPE (TECHNICAL COMPONENT) SHALL CONTAIN THE FOLLOWING:

#### 1. ELIGIBILITY DOCUMENTS

- a. (CLASS A)
- PhilGEPs Certificate of Registration and Membership under Platinum Category (all pages) in accordance with Section 8.5.2 of the Revised IRR of RA, 9184;

Note: The failure by the prospective bidder to update its Certificate with the current and updated Class "A" eligibility documents shall result in the automatic suspension of the validity of its Certificate until such time that all of the expired Class "A" eligibility documents has been updated

- Special PCAB License in case of Joint Ventures; and registration for the type and cost of the contract to be bid
- Statement of all its ongoing government and private contracts if any, whether similar or not similar in nature and complexity to the contract to be bid (NPCSF-INFR-02)
- ➤ The Statement of the bidder's Single Largest Completed Contract (SLCC) similar to the contract to be bid, and whose value, adjusted to current prices using the Philippine Statistics Authority (PSA) consumer price index, must be at least 50% of the ABC (NPCSF-INFR-03) complete with the following supporting documents:
  - Owner's Certificate of Final Acceptance issued by the project owner other than the contractor or a final rating of at least Satisfactory in the Constructors Performance Evaluation System (CPES). In case of contracts with the private sector, an equivalent document (Ex. Official Receipt or Sales Invoice) shall be submitted

(The Single Largest Completed Contract (SLCC) as declared by the bidder shall be verified and validated to ascertain such completed contract. Hence, bidders must ensure access to sites of such projects/equipment to NPC representatives for verification and validation purposes during post-qualification process.

It shall be a ground for disqualification, if verification and validation cannot be conducted due to inaccessibility of the site for whatever reason or fault of the bidder.)

- Special PCAB License in case of Joint Ventures
- Duly signed computation of its Net Financial Contracting Capacity (NFCC) at least equal to the ABC (NPCSF-INFR-04);
- b. (CLASS B)
- > Valid Joint Venture Agreement, if applicable (NPCSF-INFR-05)

#### 2. Technical Documents

- Bid Security, any one of the following:
  - Bid Securing Declaration (NPCSF-INFR-06c)
     OR
  - Cash or Cashier's/Manager's check issued by a Universal or Commercial Bank 2% of ABC;

OR

Standard Form No: NPCSF-INFR-01 Page 2 of 3

> Bank draft/guarantee or irrevocable letter of credit issued by a Universal or Commercial Bank: (NPCSF-INFR-06a) - 2% of ABC;

OR

- Surety Bond callable upon demand issued by a reputable surety or insurance company (NPCSF-INFR-06b) - 5% of ABC, with
  - Certification from the Insurance Commission as authorized company to issue surety
- ➤ Duly signed, completely filled-out and notarized Omnibus Sworn statement (Revised) (NPCSF-INFR-07), complete with the following attachments:
  - · For Sole Proprietorship:
    - Special Power of Attorney
  - For Partnership/Corporation/Cooperative/Joint Venture:
    - Document showing proof of authorization (e.g., duly notarized Secretary's Certificate, Board/Partnership Resolution, or Special Power of Attorney, whichever is applicable)
- Organization Chart for the project (NPCSF-INFR-08)
- Duly Signed and completely filled-out List of Contractor's Key Personnel (based on the minimum key personnel) (NPCSF-INFR-09)
- ➤ Duly Signed List of Contractor's Equipment (owned, leased or under purchase agreement (NPCSF-INFR-12)
- Documents to be submitted with the Bid Proposal as specified in Annex A of Section VI Part II, Technical Data Sheet (Electrical Works)
- Complete eligibility documents of proposed sub-contractor, if applicable

### B. THE 2<sup>ND</sup> ENVELOPE (FINANCIAL COMPONENT) SHALL CONTAIN THE FOLLOWING:

- Duly signed Bid Letter indicating the total bid amount in accordance with the prescribed form (NPCSF-INFR-13)
- Duly signed and completely filled-out Bill of Quantities (Section VII) indicating the unit and total prices per item and the total amount in the prescribed Bill of Quantities form.
- Duly Signed Detailed Estimates for each items of work showing the computations in arriving at each item's unit prices used in coming up with the bid (NPCSF-INFR-14)
- Summary sheets indicating the direct unit prices of construction materials, labor rates and equipment rental rates used in coming up with the bid (NPCSF-INFR-15)

**BID DOCUMENTS** 

SUPPLY, DELIVERY, CONSTRUCTION, INSTALLATION, TESTING AND COMMISSIONING OF 10MVA MASBATE (MALINTA) SUBSTATION

SECTION VIII - BIDDING FORMS

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Standard Form No: NPCSF-INFR-01 Page 3 of 3

#### **CONDITIONS:**

- 1. Each Bidder shall submit Two (2) copies of the first and second components of its Bid, marked Original and photocopy. Only the original copy will be read and considered for the bid. Any misplaced document outside of the Original copy will not be considered. The photocopy is <u>ONLY FOR REFERENCE</u>. NPC may request additional hard copies and/or electronic copies of the Bid. However, failure of the Bidders to comply with the said request shall not be a ground for disqualification.
- 2. A Bidder not submitting bid for reason that his cost estimate is higher than the ABC, is required to submit his letter of non-participation/regret supported by corresponding detailed estimates. Failure to submit the two (2) documents shall be understood as acts that tend to defeat the purpose of public bidding without valid reason as stated under Section 69.1.(i) of the revised IRR of R.A. 9184.

Standard Form Number: NPCSF-INFR-02

<b>List of All Ongoing Gove</b>	rnment and Private Cont	racts including Contract	Awarded But N	ot Yet S	Started	
Business Name : Business Address :						
	a. Owner's Name		Contractor's R	ole	a.Date Awarded	Value of
Name of Contract/Location/ Project Cost	b. Address c. Telephone Nos.	Nature of Work	Description %		b.Date Started c.Date of Completion or Estimated Completion Time	Outstanding Works
Government						
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Private						
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					1	
		<del>-  -</del>				
				+		
					Total Cost	

The bidder shall declare in this form all his on-going government and private contracts including contracts where the bidder (either as individual or as a Joint Venture) is a partner in a Joint Venture agreement other than his current joint venture where he is a partner. Non declaration will be a ground for disqualification of bid.

Note: This statement shall be supported with the following documents for all the contract(s) stated above which shall be submitted during Post-qualification:

- 1. Contract/Purchase Order and/or Notice of Award
- 2. Certification coming from the project owner/client that the performance is satisfactory as of the bidding date/signed Status Report as of the bidding date from Bureau of Construction containing relevant details of slippage, if any, for the declared on-going contracts with Department of Public Works and Highways (DPWH)

Submitted by	: _	
		(Printed Name & Signature)
Designation	: _	
Date	: _	

LuzP23Z1636Sce

Standard Form Number: NPCSF-INFR-03

#### The Statement of the bidder's Single Largest Completed Contract (SLCC) similar to the contract to be bid

Business Name : Business Address : Business Address : Business Address : Business Address : Business Name		<del></del>					
	a. Owner's Name		Contractor's I	Role	a.Amount at Award	a. Date Awarded	
Name of Contract	b. Address c. Telephone Nos.	Nature of Work	Description	%	b.Amount at Completion c. Duration	b. Contract Effectivity c. Date Completed	
[							

- Notes: 1. The bidder must state only one (1) Single Largest Completed Contract (SLCC) similar to the contract to be bid.
  - 2. Supporting documents such as any of the following: Owner's Certificate of Final Acceptance issued by the project owner other than the contractor; or A final rating of at least Satisfactory in the Constructors Performance Evaluation System (CPES); or Official Receipt (O.R); or Sales Invoice for the contract stated above shall be submitted during Bid Opening.

Submitted by		
		(Printed Name & Signature)
Designation	:	
Date	: _	

Submitted by:

Standard Form Number: NPCSF-INFR-04

#### **NET FINANCIAL CONTRACTING CAPACITY (NFCC)**

Summary of the Bidder's/Contractor's assets and liabilities on the basis of the income tax
return and audited financial statement for the immediately preceding calendar year are:

		Year 20
1.	Total Assets	
2.	Current Assets	
3.	Total Liabilities	
4.	Current Liabilities	
5.	Net Worth (1-3)	
6.	Net Working Capital (2-4)	

В.	The Net Financial	Contracting	Capacity	(NFCC)	based	on t	he a	above	data	is	computed	as
	follows:										•	

NFCC = [(Current assets minus current liabilities) x 15] minus the value of all outstanding or uncompleted portions of the projects under ongoing contracts, including awarded contracts yet to be started coinciding with the contract for this Project.

NFCC = P	

Herewith attached is certified true copy of the audited financial statement, stamped "RECEIVED" by the BIR or BIR authorized collecting agent for the immediately preceding calendar year.

,	
Name of Bidder/Contractor	
Signature of Authorized Representative	
Date:	

Standard Form Number: NPCSF-INFR-05

#### JOINT VENTURE AGREEMENT

#### **KNOW ALL MEN BY THESE PRESENTS:**

	MENT is entered into by and between: (civil status) , authorized representative of tof
-	and -
, of legal age, <i>(ci</i>	vil status) , authorized representative of
	ner their capital, manpower, equipment, and other ure to participate in the Bidding and Undertaking of <b>Power Corporation.</b>
NAME OF PROJECT	CONTRACT AMOUNT
That the capital contribution of each m	ember firm:
NAME OF FIRM	CAPITAL CONTRIBUTION
<u>1.</u>	₽ ₽
Bidding and Undertaking of the said contract.  That both parties agree that be the Official Representative/s of the Joint V do, execute and perform any and all acts need	and severally liable for their participation in the and/or shall enture, and are granted full power and authority to essary and/or to represent the Joint Venture in the as fully and effectively and the Joint Venture may substitution and revocation.
That this Joint Venture Agreement Contract until terminated by both parties.	shall remain in effect only for the above stated
Name & Signature of Authorized Representative	Name & Signature of Authorized Representative
Official Designation	Official Designation
Name of Firm	Name of Firm
Wi	itnesses
1	2

[Jurat]
[Format shall be based on the latest Rules on Notarial Practice]

Standard Form Number: NPCSF-INFR-06a

(Signature, Name and Address)

#### FORM OF BID SECURITY (BANK GUARANTEE)

WHER	EAS, (Name of Bidder)	(hereinafter called "the Bidder") has				
	ted his bid dated (Date	for the <u>[name of project]</u> (hereinafter called "the				
Bid").						
KNOW	ALL MEN by these	presents that We (Name of Bank) of				
<u>(Name d</u>	of Country)	having our registered office at				
(herein	after called "the Bank"	are bound unto National Power Corporation (hereinafter called "the				
		nt in words & figures as prescribed in the bidding documents] for				
		ily to be made to the said Entity the Bank binds himself, his				
succes	sors and assigns by th	ese presents.				
SEALE	D with the Common S	eal of the said Bank this day of 20				
THE C	ONDITIONS of this obl	igation are that:				
1)	if the Bidder withdray	s his Bid during the period of bid validity specified in the Bidding				
ŕ	Documents; or	and the same of th				
ο,	if the Didden door a					
2)		ot accept the correction of arithmetical errors of his bid price in astructions to Bidder; or				
	accordance with the n	islidelions to bidder, or				
3)	if the Bidder, having	determined as the LCB, fails or refuses to submit the required tax				
	clearance, latest inco	me and business tax returns and PhilGEPs registration certificate				
	within the prescribed					
4)	if the Bidder having b	een notified of the acceptance of his bid and award of contract to				
•	him by the Entity during the period of bid validity:					
	a) faile ar raficace to	over the the Combination				
	a) lails of refuses to	execute the Contract; or				
	b) fails or refuses to	submit the required valid JVA, if applicable; or				
	c) fails or refuses	to furnish the Performance Security in accordance with the				
	Instructions to Bid	ders;				
WA IIN	dertake to nav to the	Entity up to the above amount upon receipt of his first written				
deman	d without the Entity h	Entity up to the above amount upon receipt of his first written aving to substantiate its demand, provided that in his demand the				
Entity v	will note that the amou	nt claimed by it is due to the occurrence of any one or combination				
of the f	our (4) conditions state	d above.				
The C	uarantaa will romain i-	s former con to 100 decree of an after a contract of 111 and 11				
extend	uarantee will remain in ed by the Entity notice	force up to 120 days after the opening of bids or as it may be of which extension(s) to the Bank is hereby waived. Any demand				
in resp	ect of this Guarantee s	hould reach the Bank not later than the above date.				
•						
DATE		SIGNATURE OF THE BANK				
LAZITKIT	.00					
AALLIME	SS	SEAL				

Standard Form Number: NPCSF-INFR-06b

#### FORM OF BID SECURITY (SURETY BOND)

BOND	NO	.: DATE BOND EXECUTED:					
of Sure transac unto N (amou payme ourselv	ety) ct botation ent in ont coves,	ond, We (Name of Bidder) (hereinafter called "the Principal") and (Name of (Name of Country of Surely) , authorized to usiness in the Philippines (hereinafter called "the Surety") are held and firmly bound nal Power Corporation (hereinafter called "the Employer") as Obligee, in the sum of words & figures as prescribed in the bidding documents), callable on demand, for the of which sum, well and truly to be made, we, the said Principal and Surety bind our successors and assigns, jointly and severally, firmly by these presents.					
WHER	EAS	S, the Principal has submitted a written Bid to the Employer dated the day of 20, for the the Bid").					
NOW,	THE	EREFORE, the conditions of this obligation are:					
1)		he Bidder withdraws his Bid during the period of bid validity specified in the Bidding cuments; or					
2)	if the Bidder does not accept the correction of arithmetical errors of his bid price in accordance with the Instructions to Bidder; or						
3)	if the Bidder, having determined as the LCB, fails or refuses to submit the required tax clearance, latest income and business tax returns and PhilGEPs registration certificate within the prescribed period; or						
4)	if ti him	he Bidder having been notified of the acceptance of his bid and award of contract to by the Entity during the period of bid validity:					
	d)	fails or refuses to execute the Contract; or					
	e)	fails or refuses to submit the required valid JVA, if applicable; or					
	f)	fails or refuses to furnish the Performance Security in accordance with the Instructions to Bidders;					
then th	is ol	bligation shall remain in full force and effect, otherwise it shall be null and void.					
PROV	IDE	O HOWEVER, that the Surety shall not be:					

- a) liable for a greater sum than the specified penalty of this bond, nor
- b) liable for a greater sum that the difference between the amount of the said Principal's Bid and the amount of the Bid that is accepted by the Employer.

LuzP23Z1636Sce

Standard Form Number: NPCSF-INFR-06b Page 2 of 2

This Surety executing this instrument hereby agrees that its obligation shall be valid for 120 calendar days after the deadline for submission of Bids as such deadline is stated in the Instructions to Bidders or as it may be extended by the Employer, notice of which extension(s) to the Surety is hereby waived.

PRINCIPAL	SURETY
SIGNATURE(S)	SIGNATURES(S)
NAME(S) AND TITLE(S)	NAME(S)
SEAL	SEAL

(MALINTA) SUBSTATION
LuzP23Z1636Sce

Standard Form No: NPCSF-INFR-06c

REPUBLIC OF THE PHILIPPINES)	
CITY OF	) S.S.

## BID-SECURING DECLARATION SUPPLY, DELIVERY, CONSTRUCTION, INSTALLATION, TESTING AND COMMISSIONING OF 10MVA MASBATE (MALINTA) SUBSTATION LuzP23Z1636Sce

To: National Power Corporation Gabriel Y. Itchon Building

Sen. Miriam P. Defensor-Santiago Avenue (formerly BIR Road) cor. Quezon Avenue, Diliman, Quezon City Philippines 1100

I/We<sup>1</sup>, the undersigned, declare that:

- 1. I/We understand that, according to your conditions, bids must be supported by a Bid Security, which may be in the form of a Bid-Securing Declaration.
- 2. I/We accept that: (a) I/we will be automatically disqualified from bidding for any contract with any procuring entity for a period of two (2) years upon receipt of your Blacklisting Order; and, (b) I/we will pay the applicable fine provided under Section 6 of the Guidelines on the Use of Bid Securing Declaration, within fifteen (15) days from receipt of the written demand by the Procuring Entity for the commission of acts resulting to the enforcement of the Bid Securing Declaration under Sections 23.1 (b), 34.2, 40.1 and 69.1, except 69.1 (f) of the IRR of R.A. 9184; without prejudice to other legal action the government may undertake.
- 3. I/We understand that this Bid-Securing Declaration shall cease to be valid on the following circumstances:
  - (a) Upon expiration of the bid validity period, or any extension thereof pursuant to your request;
  - (b) I am/we are declared ineligible or post-disqualified upon receipt of your notice to such effect, and (i) I/we failed to timely file a request for reconsideration or (ii) I/we filed a waiver to avail of said right;
  - (c) I am/we are declared as the bidder with the Lowest Calculated and Responsive Bid, and I/we have furnished the performance security and signed the Contract.

	IN WITNESS	WHEREOF, I/we have hereunto set my ha	and this	 day o	f
20	_ at	, Philippines.			

[Name and Signature of Bidder's Representative/ Authorized Signatory]/ [Signatory's legal capacity] Affiant

#### [Jurat]

[Format shall be based on the latest Rules on Notarial Practice]

 $<sup>{\</sup>it I}$  Select one and delete the other. Adopt same instruction for similar terms throughout the document.

Standard Form No: NPCSF-INFR-07b

#### **Omnibus Sworn Statement (Revised)**

REPUBLIC OF THE PHILIPPII	NES)
CITY/MUNICIPALITY OF	) S.S

#### **AFFIDAVIT**

- I, [Name of Affiant], of legal age, [Civil Status], [Nationality], and residing at [Address of Affiant], after having been duly sworn in accordance with law, do hereby depose and state that:
- 1. [Select one, delete the other:]

[If a sole proprietorship:] I am the sole proprietor or authorized representative of [Name of Bidder] with office address at [address of Bidder];

[If a partnership, corporation, cooperative, or joint venture:] I am the duly authorized and designated representative of [Name of Bidder] with office address at [address of Bidder];

2. [Select one, delete the other:]

[If a sole proprietorship:] As the owner and sole proprietor, or authorized representative of [Name of Bidder], I have full power and authority to do, execute and perform any and all acts necessary to participate, submit the bid, and to sign and execute the ensuing contract for [Name of the Project] of the [Name of the Procuring Entity], as shown in the attached duly notarized Special Power of Attorney;

[If a partnership, corporation, cooperative, or joint venture:] I am granted full power and authority to do, execute and perform any and all acts necessary to participate, submit the bid, and to sign and execute the ensuing contract for [Name of the Project] of the [Name of the Procuring Entity], as shown in the attached [state title of attached document showing proof of authorization (e.g., duly notarized Secretary's Certificate, Board/Partnership Resolution, or Special Power of Attorney, whichever is applicable;)];

- 3. [Name of Bidder] is not "blacklisted" or barred from bidding by the Government of the Philippines or any of its agencies, offices, corporations, or Local Government Units, foreign government/foreign or international financing institution whose blacklisting rules have been recognized by the Government Procurement Policy Board, by itself or by relation, membership, association, affiliation, or controlling interest with another blacklisted person or entity as defined and provided for in the Uniform Guidelines on Blacklisting;
- Each of the documents submitted in satisfaction of the bidding requirements is an authentic copy of the original, complete, and all statements and information provided therein are true and correct;
- 5. [Name of Bidder] is authorizing the Head of the Procuring Entity or its duly authorized representative(s) to verify all the documents submitted;
- 6. [Select one, delete the rest:]

[If a sole proprietorship:] The owner or sole proprietor is not related to the Head of the Procuring Entity, members of the Bids and Awards Committee (BAC), the Technical Working Group, and the BAC Secretariat, the head of the Project Management Office or the end-user unit, and the project consultants by consanguinity or affinity up to the third civil degree;

[If a partnership or cooperative:] None of the officers and members of [Name of Bidder] is related to the Head of the Procuring Entity, members of the Bids and Awards Committee (BAC), the Technical Working Group, and the BAC Secretariat, the head of the Project Management Office or the end-user unit, and the project consultants by consanguinity or affinity up to the third civil degree;

[If a corporation or joint venture:] None of the officers, directors, and controlling stockholders of [Name of Bidder] is related to the Head of the Procuring Entity, members of the Bids and Awards Committee (BAC), the Technical Working Group, and the BAC Secretariat, the head of the Project Management Office or the end-user unit, and the project consultants by consanguinity or affinity up to the third civil degree;

- 7. [Name of Bidder] complies with existing labor laws and standards; and
- 8. [Name of Bidder] is aware of and has undertaken the responsibilities as a Bidder in compliance with the Philippine Bidding Documents, which includes:
  - a. Carefully examining all of the Bidding Documents;
  - Acknowledging all conditions, local or otherwise, affecting the implementation of the Contract;
  - Making an estimate of the facilities available and needed for the contract to be bid, if any; and
  - d. Inquiring or securing Supplemental/Bid Bulletin(s) issued for the [Name of the Project].
- [Name of Bidder] did not give or pay directly or indirectly, any commission, amount, fee, or any form of consideration, pecuniary or otherwise, to any person or official, personnel or representative of the government in relation to any procurement project or activity.
- 10. In case advance payment was made or given, failure to perform or deliver any of the obligations and undertakings in the contract shall be sufficient grounds to constitute criminal liability for Swindling (Estafa) or the commission of fraud with unfaithfulness or abuse of confidence through misappropriating or converting any payment received by a person or entity under an obligation involving the duty to deliver certain goods or services, to the prejudice of the public and the government of the Philippines pursuant to Article 315 of Act No. 3815 s. 1930, as amended, or the Revised Penal Code.

IN	WITNESS	WHEREOF,	-	have	hereunto	set	my	hand	this	_	day	of	,	20	at
		, Philippines.					_				_				

[Insert NAME OF BIDDER OR ITS AUTHORIZED REPRESENTATIVE]
[Insert signatory's legal capacity]
Affiant

[Jurat]

[Format shall be based on the latest Rules on Notarial Practice]

Standard Form Number: NPCSF-INFR-08

#### CONTRACTOR'S ORGANIZATIONAL CHART FOR THE CONTRACT

Con	mit Copy of the Organizational Chart that the Contractor intends to use to execute the tract if awarded to him. Indicate in the chart the names of the Project Manager, Project ineer, Foreman and other Key Engineering Personnel.
	Attach the required Proposed Organizational Chart for the Contract as stated above

#### NOTES:

- 1. This organization chart should represent the "Contractor's Organization" required for the Project, and not the organizational chart of the entire firm.
- Each such nominated engineer/key personnel shall comply with and submit duly accomplished forms NPCSF-INFR-10a, NPCSF-INFR-10b and NPCSF-INFR-11, which shall be submitted during post-qualification.
- 3. All these are required to be in the Technical Envelope of the Bidder.

ДΙ	n.	DO	OL.	INA	EΝ	ì٦	œ.

SUPPLY, DELIVERY, CONSTRUCTION, INSTALLATION, TESTING AND COMMISSIONING OF 10MVA MASBATE (MALINTA) SUBSTATION

LuzP23Z1636Sce

Standard Form Number: NPCSF-INFR-09

#### LIST OF KEY PERSONNEL PROPOSED TO BE ASSIGNED TO THE CONTRACT

(Based on the Minimum Key Personnel Required in the Bidding Documents)

Business Name: Business:					
Particulars	Project Manager (if applicable)	Project Engineer	Materials Engineer (if applicable)	Safety Officer	
1 Name					
2 Address					
B Date of Birth				•	
4 Education					
5 License/Qualification Details:					
a. Profession/Specialization					
b. Registration Number					
c. Registration Date					
d. Valid Until					
Experience Data:					
a. Years employed by the Bidder					
b. General Experience (yrs.)					
c. Professional Experience on similar project (yrs.)					
Submitted	d by:				
	-	(Printed Name & S	Signature)	_	
Designa	tion:				
	Date:			_	

One of the requirements from the bidder to be included in its Technical Envelope is a list of contractor's key personnel (based on the minimum key personnel required in the bidding documents) to be assigned to the contract to be bid, with their complete qualification and experience data.

LuzP23Z1636Sce

Standard Form Number: NPCSF-INFR-10a

NOTE: THIS FORM SHALL BE SUBMITTED DURING POST-QUALIFICATION

## KEY PERSONNEL'S CERTIFICATE OF EMPLOYMENT (PROFESSIONAL PERSONNEL)

Issuance Date THE PRESIDENT National Power Corporation Gabriel Y. Itchon Building Sen. Miriam P. Defensor-Santiago Avenue (formerly BIR Road) cor. Quezon Avenue, Diliman, Quezon City Philippines 1100 Dear Sir: I am (Name of Nominee) a Licensed Engineer with Professional License No. issued on (date of issuance) at (place of issuance) I hereby certify that (Name of Bidder) has engaged my services as (Designation) for the (Name of Project) , if awarded to it. As (Designation) , I supervised the following completed projects similar to the contract under bidding: DATE NAME OF PROJECT OWNER COST COMPLETED At present, I am supervising the following projects: DATE NAME OF PROJECT OWNER COST COMPLETED In case of my separation for any reason whatsoever from the above-mentioned Contractor, I shall notify the National Power Corporation at least twenty one (21) days before the effective date of my separation. As (Designation) \_\_\_\_\_, I know I will have to stay in the job site all the time to supervise and manage the Contract works to the best of my ability, and aware that I am authorized to handle only one (1) contract at a time. I do not allow the use of my name for the purpose of enabling the above-mentioned Contractor to qualify for the Contract without any firm commitment on my part to assume the post of (Designation) therefor, if the contract is awarded to him since I understand that to do so will be a sufficient ground for my disqualification as (Designation) in any future National Power Corporation bidding or employment with any Contractor doing business with the National Power Corporation. (Name and Signature) **AFFIANT** 

[Jurat]

[Format shall be based on the latest Rules on Notarial Practice]

One of the requirements from the bidder is a list of contractor's key personnel (viz. Project Manager, Project Engineer, Construction Safety Officer, Foremen, etc), to be assigned to the contract to be bid, with their complete qualification and experience data (including the key personnel's signed written commitment to work for the project once awarded the contract).

LuzP23Z1636Sce

Standard Form Number: NPCSF-INFR-10b

NOTE: THIS FORM SHALL BE SUBMITTED DURING **POST-QUALIFICATION** 

#### **KEY PERSONNEL'S CERTIFICATE OF EMPLOYMENT** (CONSTRUCTION SAFETY AND HEALTH OFFICER)

Issuance Date

THE PRESIDENT **National Power Corporation** Gabriel Y. Itchon Building Sen. Miriam P. Defensor-Santiago Avenue (formerly BIR Road) cor. Quezon Avenue, Diliman, Quezon City Philippines 1100 Dear Sir: an Construction Safety & Health Officer with I am (Name of Nominee) Certificate No. \_\_\_\_\_ issued on (date of issuance) at (place of issuance) I hereby certify that (Name of Bidder) has engaged my services as Construction Safety & Health Officer for the (Name of Project) , if awarded to it. I am the Construction Safety & Health Officer of the following completed projects similar to the contract under bidding: DATE NAME OF PROJECT OWNER COST COMPLETED At present, I am the Construction Safety & Health Officer of the following projects: DATE NAME OF PROJECT OWNER COST COMPLETED In case of my separation for any reason whatsoever from the above-mentioned Contractor, I shall notify the National Power Corporation at least twenty one (21) days before the effective date of my separation. As Construction Safety & Health Officer, I know I will have to stay in the job site all the time and aware that I am authorized to handle only one (1) contract at a time. I do not allow the use of my name for the purpose of enabling the above-mentioned Contractor to qualify for the Contract without any firm commitment on my part to assume the post of Construction Safety & Health Officer, if the contract is awarded to him since I understand that to do so will be a sufficient ground for my disqualification as Construction Safety & Health Officer in any future National Power Corporation bidding or employment with any Contractor doing business with the National Power Corporation. (Name and Signature) **AFFIANT** 

[Jurat]

[Format shall be based on the latest Rules on Notarial Practice]

One of the requirements from the bidder is a list of contractor's key personnel (viz. Project Manager, Project Engineer, Construction Safety Officer, Foremen, etc), to be assigned to the contract to be bid, with their complete qualification and experience data (including the key personnel's signed written commitment to work for the project once awarded the contract).

**BID DOCUMENTS** 

SUPPLY, DELIVERY, CONSTRUCTION, INSTALLATION, TESTING AND COMMISSIONING OF 10MVA MASBATE (MALINTA) SUBSTATION

SECTION VIII - BIDDING FORMS

LuzP23Z1636Sce

Standard Form Number: NPCSF-INFR-11

NOTE: THIS FORM SHALL BE SUBMITTED DURING POST-QUALIFICATION

#### KEY PERSONNEL (FORMAT OF BIO-DATA)

Give the detailed information of the following personnel who are scheduled to be assigned as full-time field staff for the project. Fill up a form for each person.

1.	Name	:
2.	Date of Birth	:
3.	Nationality	;
4.	Education and Degrees	;
5.	Specialty	:
6.	Registration	:
7.	Length of Service with the Firm	: Year from (months) (year) To (months) (year)
8.	Years of Experience	:
9.	If Item 7 is less than ten (10) employers for a ten (10)-year per	years, give name and length of service with previous iod (attached additional sheet/s), if necessary:
	Name and Address of Employer	Length of Service
40	Experience:	year(s) from to year(s) from to year(s) from to

•

This should cover the past ten (10) years of experience. (Attached as many pages as necessary to show involvement of personnel in projects using the format below).

#### **BID DOCUMENTS**

SUPPLY, DELIVERY, CONSTRUCTION, INSTALLATION, TESTING AND COMMISSIONING OF 10MVA MASBATE (MALINTA) SUBSTATION

SEC	CTION VIII - BIDDING FORMS		LuzP23Z1636Sce
	dard Form Number: NPCSF-INFR-11 e 2 of 2		
1,	Name	:	
2.	Name and Address of Owner	:	
3.	Name and Address of the Owner's Engineer (Consultant)	:	
4.	Indicate the Features of Project (particulars of the project components and any other particulars connected with the project interest connected with the project.	ular et):	
5.	Contract Amount Expressed in Philippine Currency	:	
6.	Position	:	
7.	Structures for which the employe was responsible	e :	
8.	Assignment Period	_	(years) (years)
lt is	ne and Signature of Employee hereby certified that the above parded to our company.	ersonnel can be assigned to this projec	t, if the contract is
	(Place and Date)	(The Authorized Repres	entative)

LuzP23Z1636Sce

Standard Form Number: NPCSF-INFR-12

#### LIST OF EQUIPMENT, OWNED OR LEASED AND/OR UNDER PURCHASE AGREEMENTS

(Based on the Minimum Equipment Required in the Bidding Documents)

Description	Model/Year	Capacity / Performance / Size	Plate No.	Motor No. / Body No.	Location	Condition	Proof of Ownership Lessor or Vendor
Owned			,	<u> </u>			
						_	
1			<u></u>				
Leased		<u> </u>	<del></del>			<del></del>	
		<u>                                     </u>		<u> </u>		++	
	······································			<del> </del>		+	
	<del>-</del>			<del>                                     </del>			
•				<del>                                     </del>		·· <del>·</del>	
. Under Purchase Agre	ements		I				
		•••				!	
		_					
i							
	Submitted	by:					
			(Printed No	me & Signature)		<b>-</b>	

One of the requirements from the bidder to be included in its Technical Envelope is the list of its equipment units pledged for the contract to be bid, based on minimum equipment required in the bidding documents, which are owned, leased, and/or under purchase agreements.

This shall be supported by proof of ownership and/or certification of availability of equipment from the equipment lessor for the duration of the project, to be submitted during post-qualification.

LuzP23Z1636Sce

Standard Form No.: NPCSF-INFR-13

#### **BID LETTER**

	BID LETTER
	Date:
To:	THE PRESIDENT  National Power Corporation Gabriel Y. Itchon Building Sen. Miriam P. Defensor-Santiago Avenue (formerly BIR Road) cor. Quezon Avenue, Diliman, Quezon City Philippines 1100
We,	the undersigned, declare that:
(a)	We have examined and have no reservation to the Bidding Documents, including Addenda, for the Contract SUPPLY, DELIVERY, CONSTRUCTION, INSTALLATION, TESTING AND COMMISSIONING OF 10MVA MASBATE (MALINTA) SUBSTATION (LuzP23Z1636Sce).
(b)	We offer to execute the Works for this Contract in accordance with the Bid Documents, Technical Specifications, General and Special Conditions of Contract accompanying this Bid;
	The total price of our Bid, excluding any discounts offered below is: [insert information]
	The discounts offered and the methodology for their application are: [insert information]
(c)	Our Bid shall be valid for a period of <u>[insert number]</u> days from the date fixed for the Bid submission deadline in accordance with the Bidding Documents, and it shall remain binding upon us and may be accepted at any time before the expiration of that period;
(d)	If our Bid is accepted, we commit to obtain a Performance Security in the amount of <a href="mailto:linsert.percentage amount">linsert.percentage amount</a> percent of the Contract Price for the due performance of the Contract;
(e)	Our firm, including any subcontractors or suppliers for any part of the Contract, have nationalities from the following eligible countries: [insert information];
(f)	We are not participating, as Bidders, in more than one Bid in this bidding process, other than alternative offers in accordance with the Bidding Documents;
(g)	Our firm, its affiliates or subsidiaries, including any subcontractors or suppliers for any part of the Contract, has not been declared ineligible by the Funding Source;
(h)	We understand that this Bid, together with your written acceptance thereof included in your notification of award, shall constitute a binding contract between us, until a formal Contract is prepared and executed; and
(i)	We understand that you are not bound to accept the Lowest Calculated Bid or any other Bid that you may receive.

- (j) We likewise certify/confirm that the undersigned, is the duly authorized representative of the bidder, and granted full power and authority to do, execute and perform any and all acts necessary to participate, submit the bid, and to sign and execute the ensuing contract for the SUPPLY, DELIVERY, CONSTRUCTION, INSTALLATION, TESTING AND COMMISSIONING OF 10MVA MASBATE (MALINTA) SUBSTATION (LuzP23Z1636Sce) of the National Power Corporation.
- (k) We acknowledge that failure to sign each and every page of this Bid Letter, including the Bill of Quantities, shall be a ground for the rejection of our bid.

Name:	
In the capacity of:	
Signed:	· · · · · · · ·
Duly authorized to sign the Bid for and on behalf of:	
Date:	

~.~	~~~	
		IMENTS

SUPPLY, DELIVERY, CONSTRUCTION, INSTALLATION, TESTING AND COMMISSIONING OF 10MVA MASBATE (MALINTA) SUBSTATION

LuzP23Z1636Sce

Standard Form No.: NPCSF-INFR-14

## Name of Bidder : DETAILED COST ESTIMATE FORM

		Ï	Unit		Direct (	Cost (DC)		Mark-L	Jp (MU)			
	Item Description	Qty.	of Measure	Materials	Labor	Equipment	Transport	ОСМ	Profit	VAT	Unit Cost	Total Price
Item No.		(A)		(B)	(C)	(D)	(E)	(F)	(G)	(H)	(1)	(J)
·								[(B)+(C)+ (D)+(E)] x % OCM	((B)+(C)+ (D)+(E)] x % PROFIT	[(B)+(C)+ (D)+(E) + (F) + (G)] x % VAT	[(B)+(C)+ (D)+(E) + (F) + (G) + (H)] / (A)	(A) x (I)
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	<u> </u>					<del>  </del>						
						† ···· <del> </del>			'		+	
											TOTAL	

#### NOTES:

- 1. The Bidder must provide all the information required above.
- 2. All pay items in the Bill of Quantities must be included the detailed cost estimate.
- 3. Unit Price and Total price in this form must be the same with the Bill of Quantities and Bid Letter.

Name, Si	gnature of Authorized Representative	Designation

LuzP23Z1636Sce

Standard Form No.: NPCSF-INFR-15

## SUMMARY SHEETS OF MATERIALS PRICES, LABOR RATES AND EQUIPMENT RENTAL RATES

Na	me of Bidder :		· · · · · · · · · · · · · · · · · · ·
	Unit Prices of Materials		
	Materials Description	Unit	Unit Price
	1. 2. 3. 4. 5. 6. 7.		
	Manpower Hourly Rates		
	Designation  1. 2. 3. 4. 5. 6. 7.	Rate/Hr.	
ı.	Equipment Hourly Rental Rates		
	Equipment Description  1. 2.	Rental Rate/F	lr.
	3. 4. 5. 6. 7.		
	Name, Signature of Authorized Representative		gnation

SECTION IX - BID DRAWINGS

LuzP23Z1636Sce


# SECTION IX BID DRAWINGS



#### **SECTION IX - BID DRAWINGS**

#### **AW - ARCHITECTURAL WORKS**

<u>DRAWING NO.</u>	<u>TITLE</u>
MSS-BDA-22.001	CONTROL HOUSE (Floor Plan)
MSS-BDA-22.002	CONTROL HOUSE (Roof Plan)
MSS-BDA-22.003	CONTROL HOUSE (Reflected Ceiling Plan)
MSS-BDA-22.004	CONTROL HOUSE (Elevations)
MSS-BDA-22.005	CONTROL HOUSE (Sections)
MSS-BDA-22.006	CONTROL HOUSE (Schedule of Doors & Windows)
MSS-BDA-22.007	PUMPHOUSE (Plan & Elevation)
MSS-BDA-22.008	GUARDHOUSE (Plan, Elev. & Sched. of Doors & Windows)
MSS-BDA-22.009	UTILITIES COUNTER AND WALL CABINETS (Elevations)

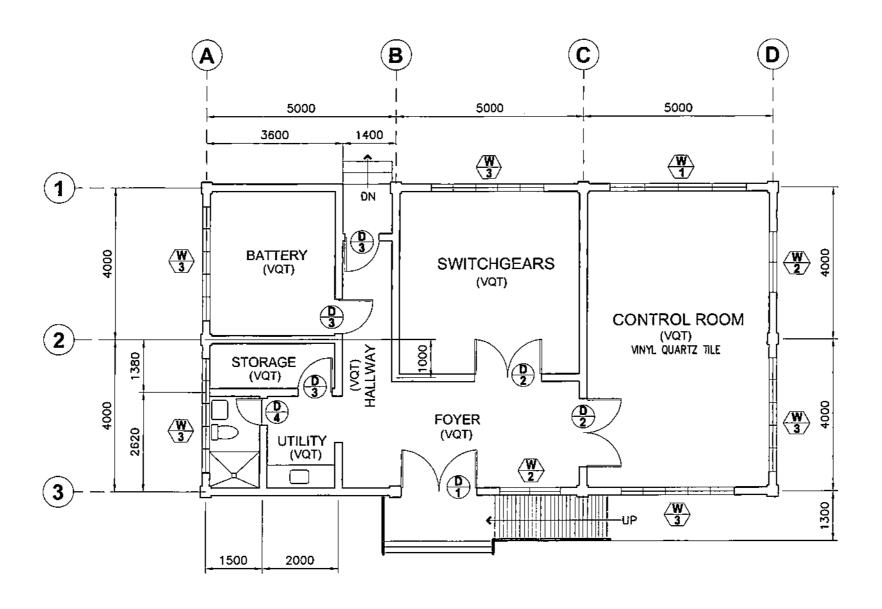



REV. DATE

NATURE OF REVISION



NATIONAL POWER CORPORATION
GABRIEL Y. ITCHON BLDG., SEN, MIRIAM P. DEFENSOR: SANTIAGO
AVENUE (FORMERLY BIR ROAD) CORNER CUEZON AVENUE,
DILIMAN 1100 QUEZON CITY, PHILIPPINES

PROJECT: SUPPLY, DELIVERY, CONSTRUCTION, INSTALLATION, TESTING AND COMMISSIONING OF 10 MVA MASBATE (MALINTA) SUBSTATION

LOCATION: MALINTA, MASBATE

CONTROL HOUSE (FLOOR PLAN)

1	BY	CHKD	CATE	I -Angles -
DESIGNED		_		SUBMITTED: R. R. R. VILLANUEVA
DRAWN				Principal Architect A. CEAD
REVIEWED	PRINCIPA	L ENG'R. /	ARCH'T.	RECOMMENDED: A. C. ESPIRITU
CML/ARCHT			Í	Manager, CEAD
ELEC.				APPROVED: G. B. MAGPOC JR.
MECH.				Monager, DDO


DWG. NO. MSS-BDA-22.001

SPECS. NO. LuzP23Z1636Sce

REV. 0

غاي الغائر بيوسي

**BID DRAWING** BY CHKO, RECD. APPO. SCALE: 1:100

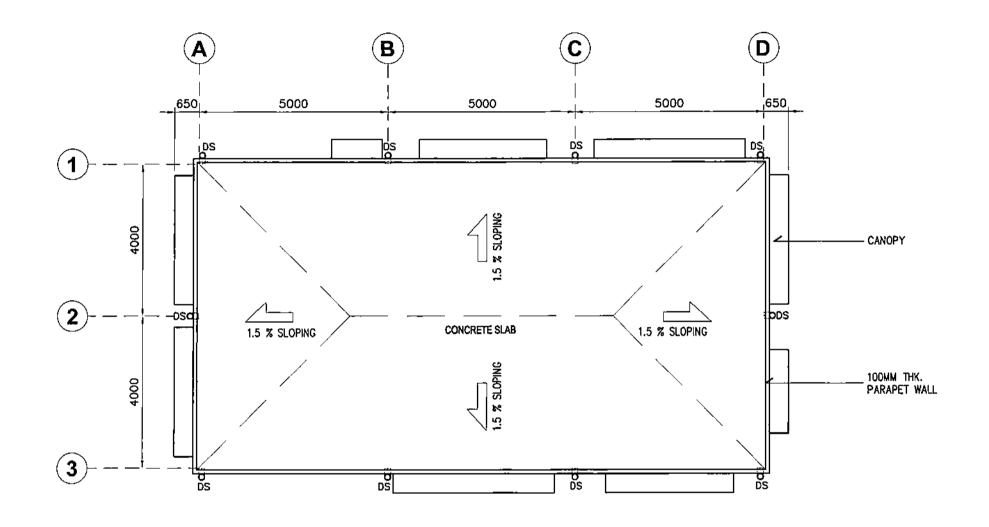

REV. DATE

NATURE OF REVISION



## NATIONAL POWER CORPORATION GABRIEL Y. ITCHON BLDG., SEN. MIRIAM P. DEFENSOR-SANTIAGO AVENUE (FORMERLY BIR ROAD) CORNER QUEZON AVENUE, DILIMAN 1100 QUEZON CITY, PHILIPPINES

PROJECT: SUPPLY, DELIVERY, CONSTRUCTION, INSTALLATION, TESTING AND COMMISSIONING OF 10 MVA MASBATE (MALINTA) SUBSTATION

LOCATION: MALINTA, MASBATE

TITLE:

## CONTROLHOUSE (ROOF PLAN)

	BY	CHKD	DATE	_	Arrolis
DESIGNED	_			SUBMITTED:	R. R. VILLANUEVA
DRAWN				]	Principal Architect A, CEAD
REVIEWED	PRINCIPAL ENG'R. / ARCH'T.			RECONNEND	
CIVIL/ARCH'T				]	Manager, CEAD
ELEC.	1			APPROVED:	G. B.MAGPOC JR.
MECH.				<u>                                     </u>	Manager, DDD


DWG. NO. MSS-BDA-22.002

SPECS. NO. LuzP23Z1636Sce

REV. O

BY CHKD. RECD. APPD. SCALE: 1:100

**BID DRAWING** 

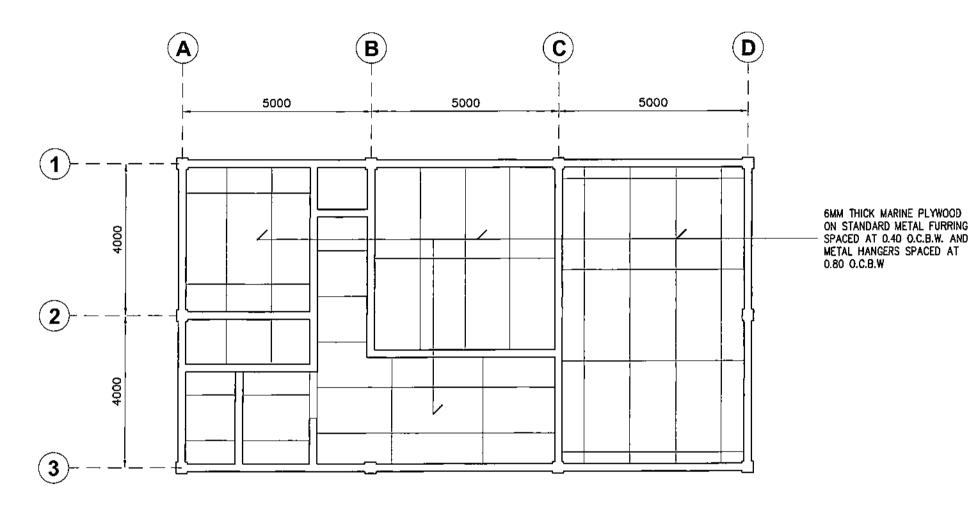





## NATIONAL POWER CORPORATION GABRIEL Y. ITCHON BLDG., SEN, MIRIAM P. DÉFENSOR-SANTIAGO AVENUE (FORMERLY BIR ROAD) CORNER QUEZON AVENUE, DILIMAN 1100 QUEZON CITY, PHILIPPINES

PROJECT: SUPPLY, DELIVERY, CONSTRUCTION, INSTALLATION, TESTING AND COMMISSIONING OF 10 MVA MASBATE (MALINTA) SUBSTATION

LOCATION: MALINTA, MASBATE

TTLE:

## CONTROLHOUSE (REFLECTED CEILING PLAN)

		CHKD-	DATE	&
DESIGNED				SUBMITTED: R.R. R. WILLANUEVA
DRAWN				Principal Architect A, CEAD
REVIEWED	PRINCIPAL ENG'R. / ARCH'T.			RECOMMENDED: A. CESPIRITU
CML/ARCH'T			j	Manager, CEAO
ELEC.			_	APPROVED: G. B. MAGPOC JR.
MECH.				Manager, 000


DWG. NO. MSS-BDA-22.003


SPECS. NO. LuzP23Z1636Sce

REV. DATE NATURE OF REVISION BY CHKO, RECD. APPO. SCALE: 1:180


BID DRAWING

REV. 0

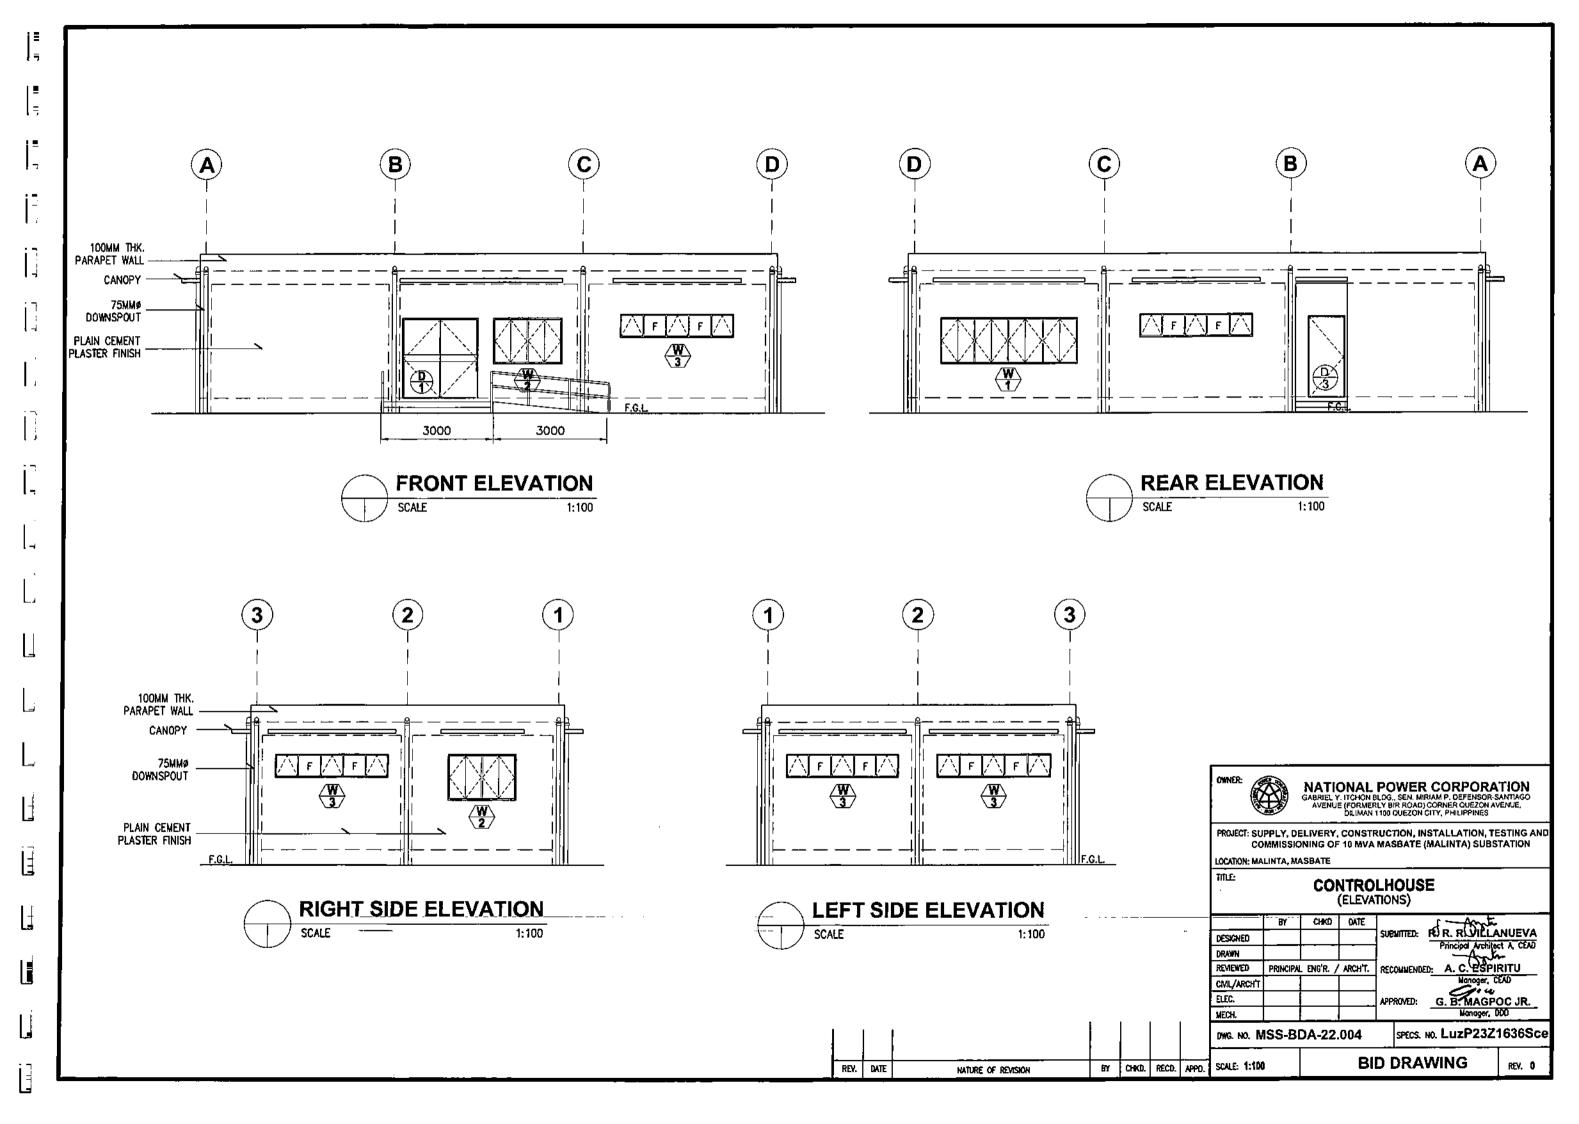

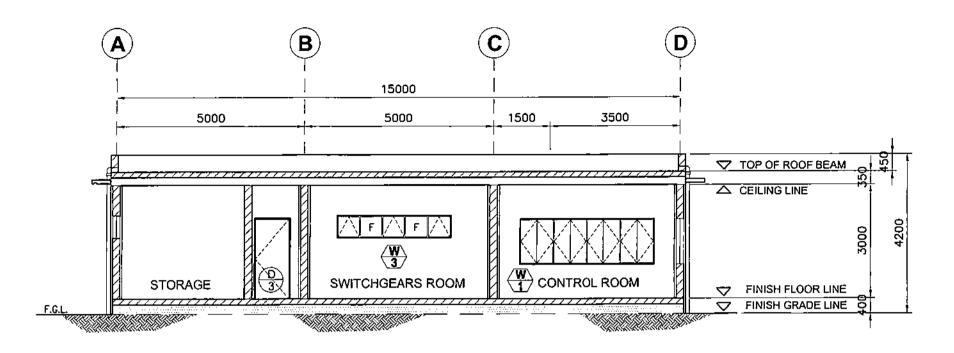



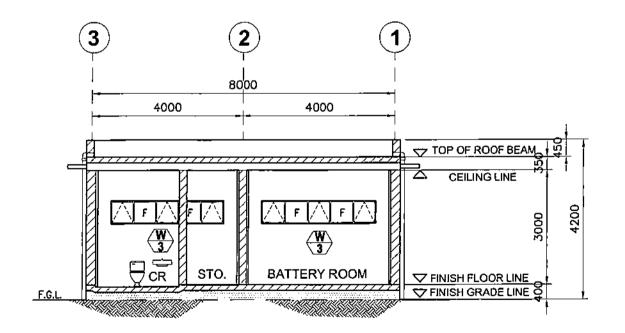





# NATIONAL POWER CORPORATION GABRIEL, Y. ITCHON BLDG., SEN. MIRIAM P. DEFENSOR-SANTIAGO AVENUE (FORMERLY BIR ROAD) CORNER QUEZON AVENUE, DILIMAN 1100 QUEZON CITY, PHILIPPINES

PROJECT: SUPPLY, DELIVERY, CONSTRUCTION, INSTALLATION, TESTING AND COMMISSIONING OF 10 MVA MASBATE (MALINTA) SUBSTATION

LOCATION: MALINTA, MASBATE

TITLE:


CONTROLHOUSE (SECTIONS)

	BY	CHKD	DATE	f -Agrapa
DESIGNED			- <del></del>	SUBMITTED: R.R. R. WILLIANUEVA
DRAWN				Principal Architect A, CEAD
REVIEWED	PRINCIPAL	. ENG'R. /	ARCH'T.	RECOMMENDED: A. C. ESPIRITU
CML/ARCH'T				Manager, CEAD
ELEC.				APPROVED: G. B. MAGPOC JR.
MECH.				Manager, 000

DWG. NO. MSS-BDA-22.005

SPECS. NO. LuzP23Z1636Sce

REV. DATE NATURE OF REVISION BY CHKO. RECO. APPD. SCALE: 1:100 BID DRAWING REV. 0

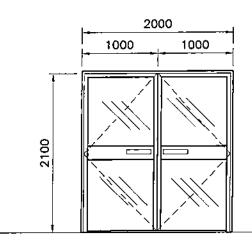



- : ANODIZED SILVER ALUMINUM
- : 6 MM THK CLEAR GLASS
- : DOUBLE SWING DOOR
- : COMPLETE ACCESSORIES AND LOCKS


1800


900

900

### **WOODEN FLUSH TYPE**

- : DOUBLE SWING
- : 2x5" HARD WD DOOR JAMB : MARINE PLYWD BOTH FACES
- : 5 MM THK CLEAR GLASS COMPLETE WITH HARDWARES
- INCLUDING HEAVY DUTY DOOR CLOSER - ONE SET

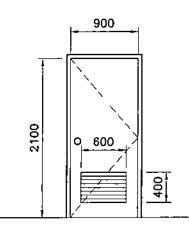

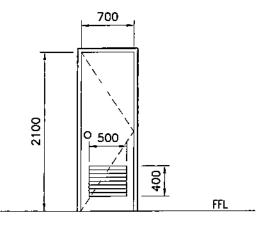

# (D) WOODEN FLUSH TYPE

- : 2x5" HARD WD DOOR JAMB : MARINE PLYWD BOTH FACES
- : 5 MM THK CLEAR GLASS : COMPLETE WITH HARDWARES INCLUDING HEAVY DUTY DOOR CLOSER - ONE SET

## WOODEN FLUSH TYPE

- : 2x5" HARD WD DOOR JAMB : MARINE PLYWD BOTH FACES
- : 5 MM THK CLEAR GLASS : COMPLETE WITH HARDWARES





## SCHEDULE OF DOORS


SCALE

1:50

REV. DATE

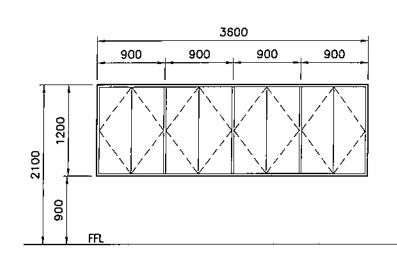

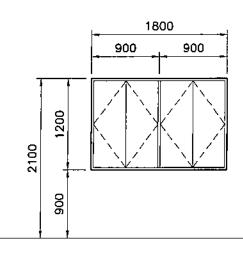

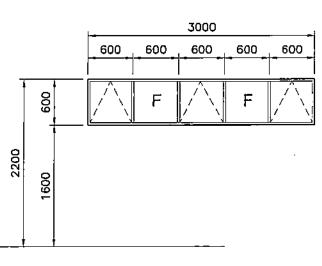

# STEEL CASEMENT WINDOW

- : 7/8 HEAVY SECTION Z-BAR : SOLID T-BAR MULLION
- : 7/32" CLEAR GLASS

STEEL CASEMENT WINDOW

: 7/8 HEAVY SECTION Z-BAR

- : SOLID T-BAR MULLION
- : 7/32" CLEAR GLASS

STEEL CASEMENT WINDOW

- : 7/8 HEAVY SECTION Z-BAR
- : SOLID T-BAR MULLION
- : 7/32" CLEAR GLASS

NATURE OF REVISION

SCHEDULE OF WINDOWS



# NATIONAL POWER CORPORATION GABRIEL Y, ITCHON BLDG., SEN. MIRIAM P. DEFENSOR-SANTIAGO AVENUE (FORMERLY BIR ROAD) CORNER QUEZON AVENUE, DILIMAN 1100 QUEZON CITY, PHILIPPINES

PROJECT: SUPPLY, DELIVERY, CONSTRUCTION, INSTALLATION, TESTING AND COMMISSIONING OF 10 MVA MASBATE (MALINTA) SUBSTATION

LOCATION: MALINTA, MASBATE

TITLE:

CONTROLHOUSE

(SCHEDULE OF DOORS & WINDOWS)


	•			
	EY	CHKD	DATÉ	&- Anch
DESIGNEO				SUBMITTED: R. R. R. WILCANUEVA Principal Architect A, CEAD
DRAWN				- Antr
REVIEWED	PRINCIPAL	L ENG'R. /	ARCH'T.	RECOMMENDED: A. CLESPIRITU
CML/ARCH'T				Manager, CEAD
ELEC.				APPROVED: G. B. MAGPOC JR.
MECH.				Manager, DDD


DWG. NO. MSS-BDA-22,006


SPECS. NO. LuzP23Z1636Sce


SCALE: AS SHOWN BY CHKD. RECD. APPD.

**BID DRAWING** 

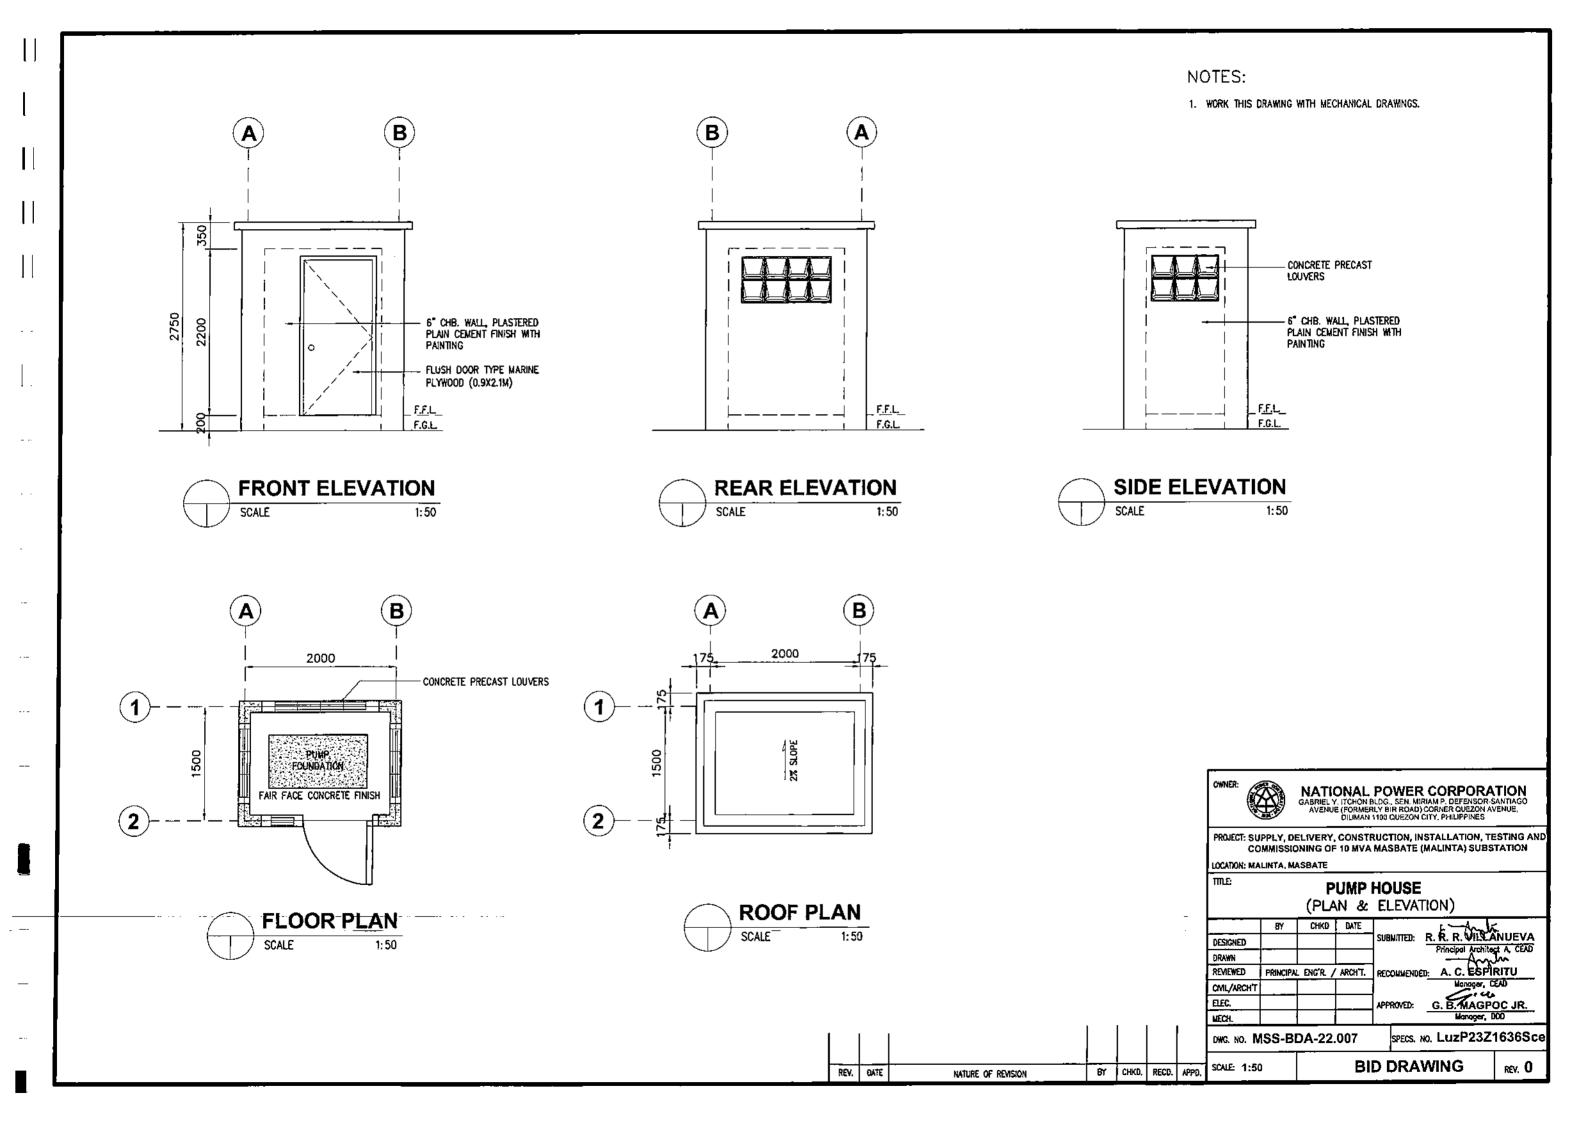

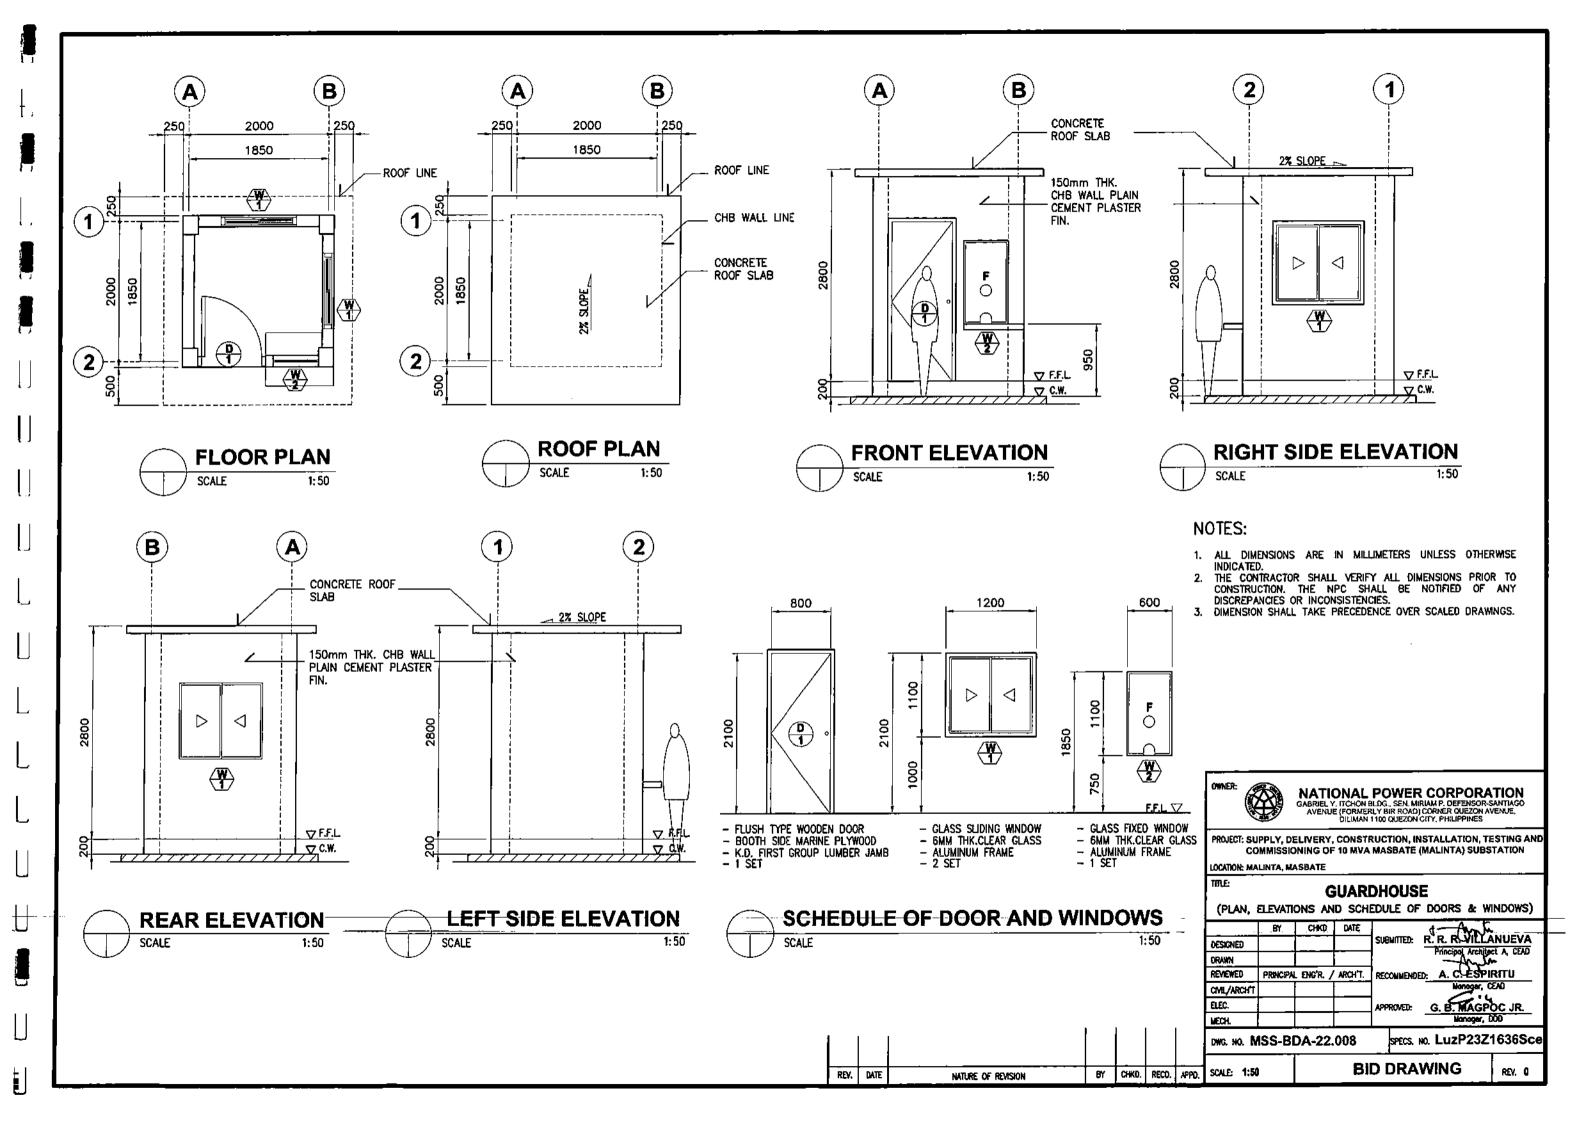

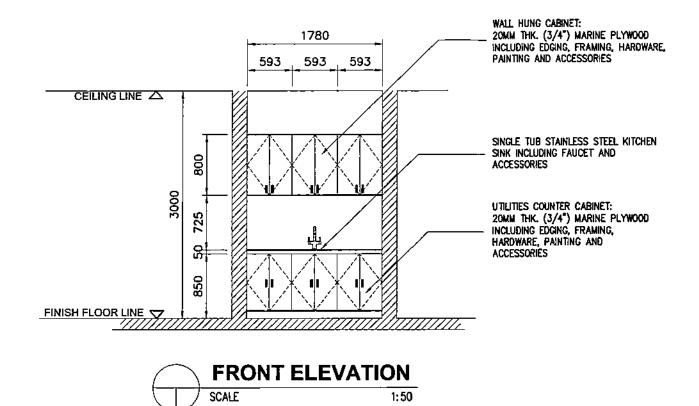

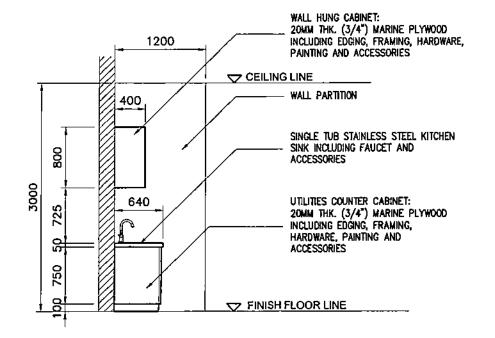


REV. DATÉ

NATURE OF REVISION



### NOTES:

- 1. ALL DIMENSIONS ARE IN MILLIMETERS UNLESS OTHERWISE INDICATED.
- 2. THE CONTRACTOR SHALL VERIFY ALL DIMENSIONS PRIOR TO CONSTRUCTION. THE NPC SHALL BE NOTIFIED OF ANY DISCREPANCIES OR INCONSISTENCIES.
- 3. DIMENSION SHALL TAKE PRECEDENCE OVER SCALED DRAWINGS.

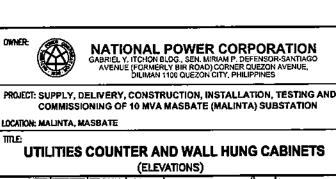

BY CHKD DATE SUBMITTED: R. R. P. VILLANUEVA DESIGNED A. C. ESPIRITU DRAWN REVIEWED PRINCIPAL ENG'R. / ARCH'T. RECOMMENDED: G. B. MAGPOC JR. CIVIL/ARCH'T Monoger, DDD MECH.

DWG. NO. MSS-BDA-22.009

BY CHKO, RECO. APPO,

SPECS. NO. LuzP23Z1636Sce

**BID DRAWING** SCALE: 1:50

LuzP23Z1636Sce

### **SECTION IX - BID DRAWINGS**


### **CW - CIVIL WORKS**

]	DRAWING NO.	TITLE
11	MSS-BDC-22.001	SITE DEVELOPMENT PLAN
	MSS-BDC-22.002	EQUIPMENT AND GANTRY STRUCTURE (Foundation Layout)
<b>Ŀ</b> I Ì	MSS-BDC-22.003	CONTROL HOUSE (Foundation and Roof Framing Plan)
L! ]'	MSS-BDC-22.004	CONTROL HOUSE (Beam and Slab Details)
L []	MSS-BDC-22.005	CONTROL HOUSE (Footing-Column, Wall Footing Details)
	MSS-BDC-22.006	PUMPHOUSE (Foundation Plan, Section, Elev. & Details)
	MSS-BDC-22.007	PUMPHOUSE (Roof Slab, Beam Section & Details)
 [	MSS-BDC-22.008	GUARDHOUSE (Fdn. Plan, Slab, Column & Wall Footing)
<u></u>	MSS-BDC-22.009	CABLE TRENCHES (Plan, Section and Details)
	MSS-BDC-22.010	TYPICAL ROADWAY (Road Plan & Section)
L	MSS-BDC-22.011	ROADWAY (Typical Details)
t '	MSS-BDC-22.012	TYPICAL SECLUSION FENCE & PEDESTRIAL GATE (Elev., Section & Det.)
_	MSS-BDC-22.013	MAIN GATE (Elevation, Section & Details)




(MALINTA) SUBSTATION LuzP23Z1636Sce	SECTION IX - BID DRAWINGS
PERIMETER FENCE (Elevation, Section & Details)	MSS-BDC-22.014
FLAGPOLE & PERIMETER LIGHTING POLE FOUNDATION (Plan, Section & Det.)	MSS-BDC-22.015
ELEVATED WATER STORAGE TANK (Plan, Section, Elevation & Details)	MSS-BDC-22.016
FOUNDATION FOR EQUIPMENT & GANTRY STRUCTURES (Plan, Sec. & Det.)	MSS-BDC-22.017
TYPICAL TRANSFORMER FOUNDATION (Plan & Sections)	MSS-BDC-22.018
TYPICAL SWITCHGEAR FOUNDATION (Plan & Sections)	MSS-BDC-22.019
DRAINGE PLAN	MSS-BDC-22.020
DRAINAGE APPURTENANCES (CB-DS, Trenching, Catch Basin for PPVC Pipes)	MSS-BDC-22.021
DRAINAGE APPURTENANCES (Manhole, Perf. PVC Pipes, Open Concrete Canal)	MSS-BDC-22.022
DRAINAGE APPURTENANCES (Street Inlet-Catch Basin)	MSS-BDC-22.023
TYPICAL GROUTED RIPRAP (Elevation, Section & Details)	MSS-BDC-22.024
TYPICAL SEPTIC TANK	MSS-BDC-22.025

(Plan, Section & Details)

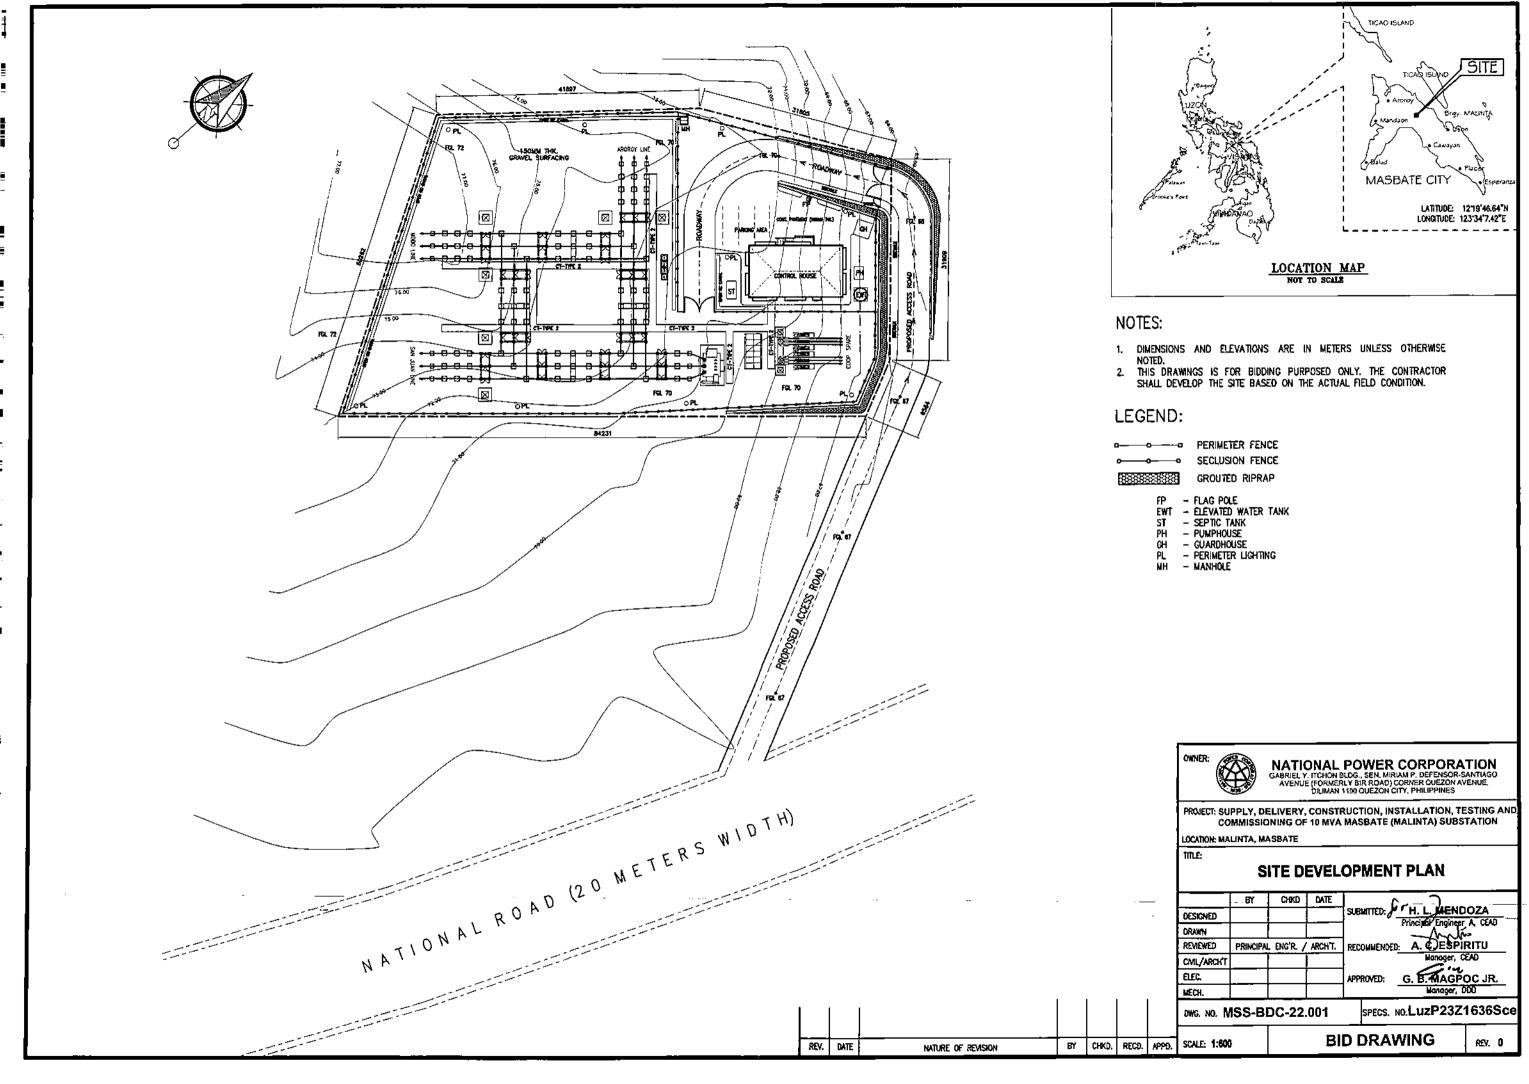

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NATURE OF REVISION
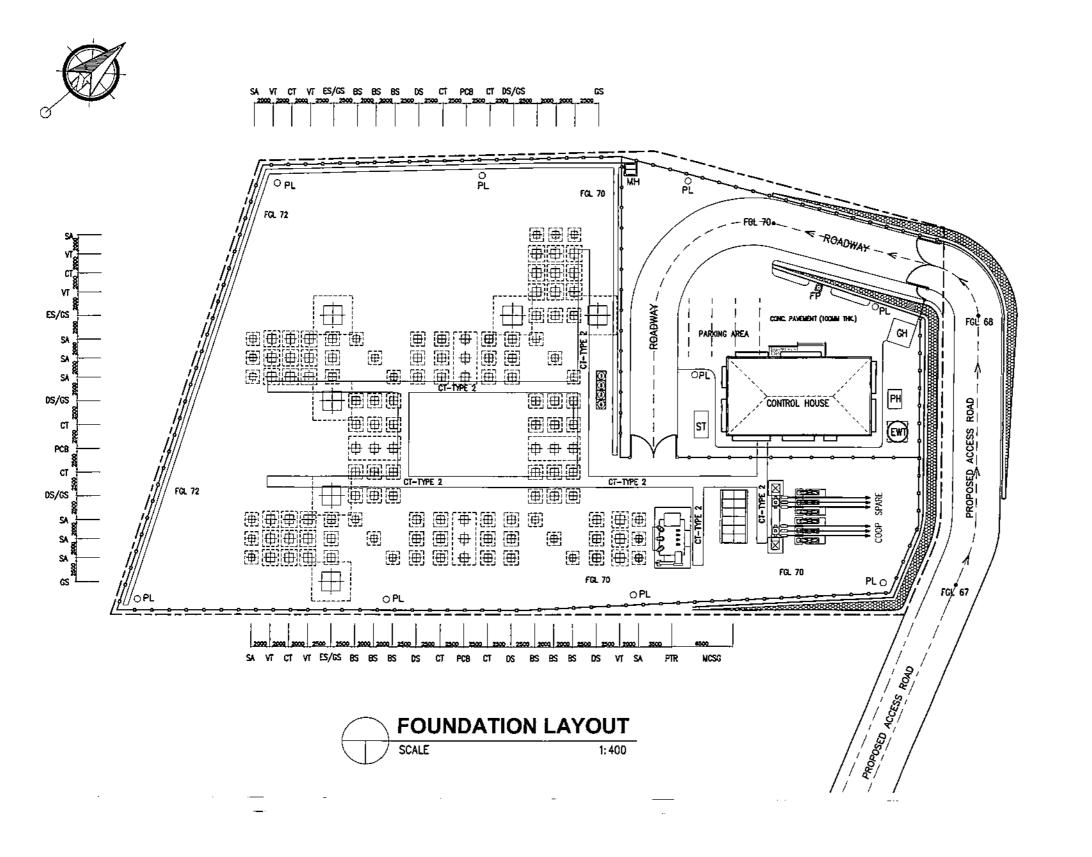
### NOTES:

- IF THERE IS A DISCREPANCY BETWEEN FOUNDATION AND EQUIPMENT LAYOUT, THE EQUIPMENT LAYOUT SHALL GOVERN.
   WORK THIS DRAWING WITH CIVIL AND ELECTRICAL DRAWINGS.

LIST OF GANTRY & EQUIPMENT STRUCTURES
69 kV GANTRY STRUCTURES (GS)
BUS SUPPORT (BS)
DISCONNECT SWITCH (DS)
SURGE ARRESTER (SA)
VOLTAGE TRANSFORMER (VT)
CURRENT TRANSFORMER (CT)
METALCLAD SWITCHGEAR (MCSG)
POST INSULATOR (PI)
EARTH SWITCH (ES)
POWER CIRCUIT BREAKER (PCB)



# NATIONAL POWER CORPORATION GABRIEL Y. ITCHON BLDG., SEN. MIRIAMP. DEFENSOR-SANTIAGO AVENUE (FORMERLY BIR ROAD) CORNER QUEZON AVENUE, DILIMAN 1106 QUEZON CITY, PHILIPPINES

PROJECT: SUPPLY, DELIVERY, CONSTRUCTION, INSTALLATION, TESTING AND COMMISSIONING OF 10 MVA MASBATE (MALINTA) SUBSTATION

LOCATION: MALINTA, MASBATE

# EQUIPMENT AND GANTRY STRUCTURE (FOUNDATION LAYOUT)


	BY	CHKO	_DATE	( )
DESIGNED				SUBMITTED: H. L. MENDOZA Principal Engineer A, CEAD
DRAWN				// / / / / / / / / / / / / / / / / / /
REVIEWED	PRINCIPAL	L ENG'R. /	' ARCH'T.	RECOMMENDED: A. CESPIRITU
CML/ARCH'T				Wangger, CEAD
ELEC.				APPROVED: G. B. MAGPOC JR.
MECH.				Manager, DDD


DWG. NO. MSS-BDC-22,002

SPECS, NO.LuzP23Z1636Sce

SY CHKD. RECO. APPD. SCALE: 1:400

**BID DRAWING** 

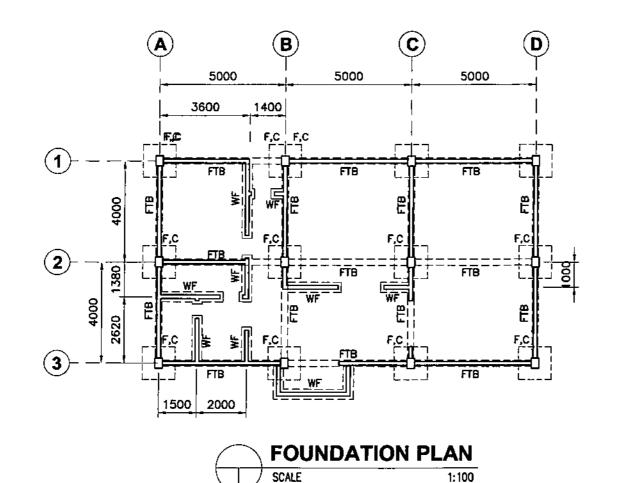

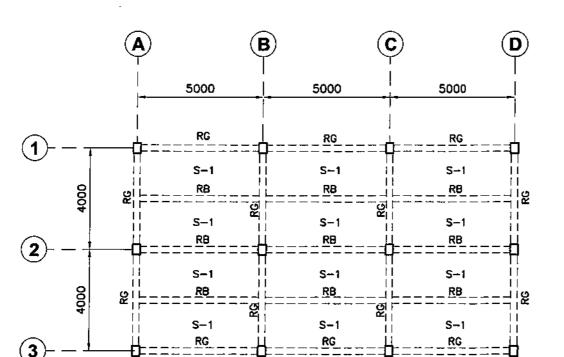





# NATIONAL POWER CORPORATION GABRIEL Y. ITCHON BLDG., SEN. MIRIAM P. DEFENSOR-SANTIAGO AVENUE (FORMERLY BIR ROAD) CORNER CLUEZON AVENUE, DILIMAN 1100 QUEZON CITY, PHILIPPINES

PROJECT: SUPPLY, DELIVERY, CONSTRUCTION, INSTALLATION, TESTING AND COMMISSIONING OF 10 MVA MASBATE (MALINTA) SUBSTATION

LOCATION: MALINTA, MASBATE

MILE:

CONTROL HOUSE
(FOUNDATION AND ROOF FRAMING PLAN)


_BY	CHKO	DATE	(,
			SUBMITTED: H. L. MENDOZA
			Principal Engineer A CEAD
PRINCIPAL	ENG'R.	ARCH'T.	RECOMMENDED: A. C. ESPIRITU
			Manager, CEAD
			APPROVED: G. B. MAGFOC JR.
			Manager, DDD
	PRINCIPAL	PRINCIPAL ENG'R.	PRINCIPAL ENG'R. / ARCH'T.


DWG. NO. MSS-BDC-22.003

SPECS. NO.LUZP23Z1636Sce

REV. DATE NATURE OF REVISION BY CHKD. RECD. APPD. SCALE: 1:100

BID DRAWING

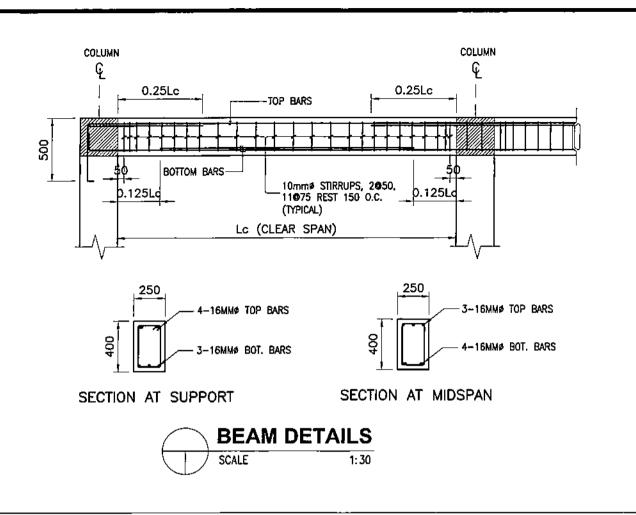

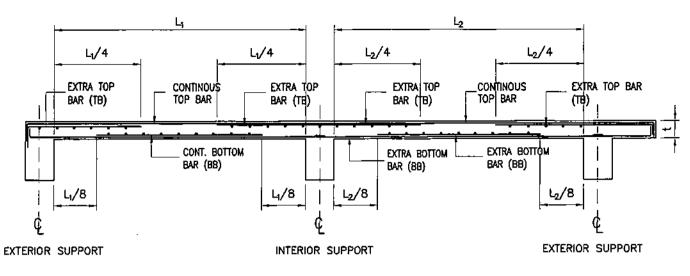





	SCHEDULE OF SLABS									
SLAB	SLAB THOUSES LEGATION		CONTINUOUS	EXTRA BARS PARALLEL TO SHORT SPAN			EXTRA BARS PARALLEL TO LONG SPAN			REMARKS
MARK	SLAB THICKNESS LOCATION	LOCATION	BAR BOTHWAYS	LEFT	MIDSPAN	RIGHT	LEFT	MIDSPAN	RIGHT	
	105	тв	ø10 <b>Ø</b> 300	ø10 <b>©</b> 300	_	ø10 😉 300	ø10 🕲 300	-	ø10 <b>@</b> 300	ONE-WAY
S-1	125	8B	ø10 <b>©</b> 300	_	ø10 <b>Ø</b> 300	_	-	ø10 <b>©</b> 300		

SCHEDULE OF REINFORCED CONCRETE BEAM									
MARK BEAM DIMENSION BXD (MM)	REBAR	LEFT		MIDSPAN		RIGHT		STRIRRUPS SPACING	
	(mmø)	TOP	воттом	TOP	воттом	TOP	воттом	2@50MM, 11@75MM,	
RB & RG	250 X 400	16mmø	4	3	3	_ 4	4	3	REST @ 150MM O.C.

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REV.

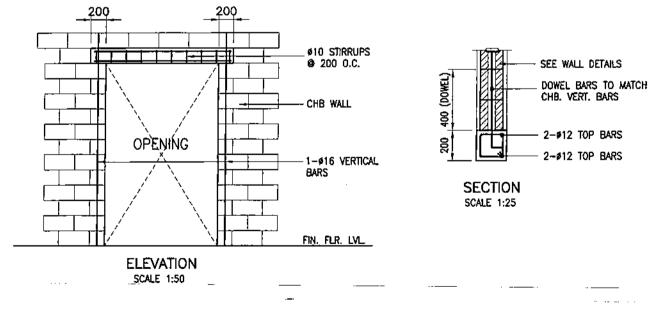

NATIONAL POWER CORPORATION
GABRIEL Y. ITCHON BLDG., SEN. MIRIAM P. DEFENSOR-SANTIAGO
AVENUE (FORMERLY BIR ROAD) CORNER QUEZON AVENUE,
DILIMAN 1100 QUEZON CITY, PHILIPPINES

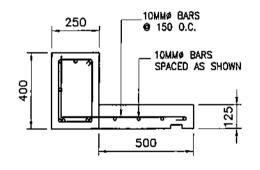PROJECT: SUPPLY, DELIVERY, CONSTRUCTION, INSTALLATION, TESTING AND COMMISSIONING OF 10 MVA MASBATE (MALINTA) SUBSTATION

LOCATION: MALINTA, MASBATE

TILE

CONTROL HOUSE (BEAM AND SLAB DETAILS)


	BY_	CHKD_	DATE	_ r. u
DESIGNED				SUBJUTTED: Principal Engineer A. CEAD
DRAWN				
REVIEWED	PRINCIPA	L ENG'R. /	ARCH'T.	RECOMMENDED: A. C. ESPIRITU
CML/ARCHT			•	Mggggar, CEAD
ELEC.	_		İ	APPROVED: G. B. MAGPOC JR.
MECH				Manager, 000


DWG. NO. MSS-BDC-22.004

SPECS. NO.LuzP23Z1636Sce


DATE NATURE OF REVISION BY CHKD, RECD. APPD. SCALE: AS SHOWN

BID DRAWING

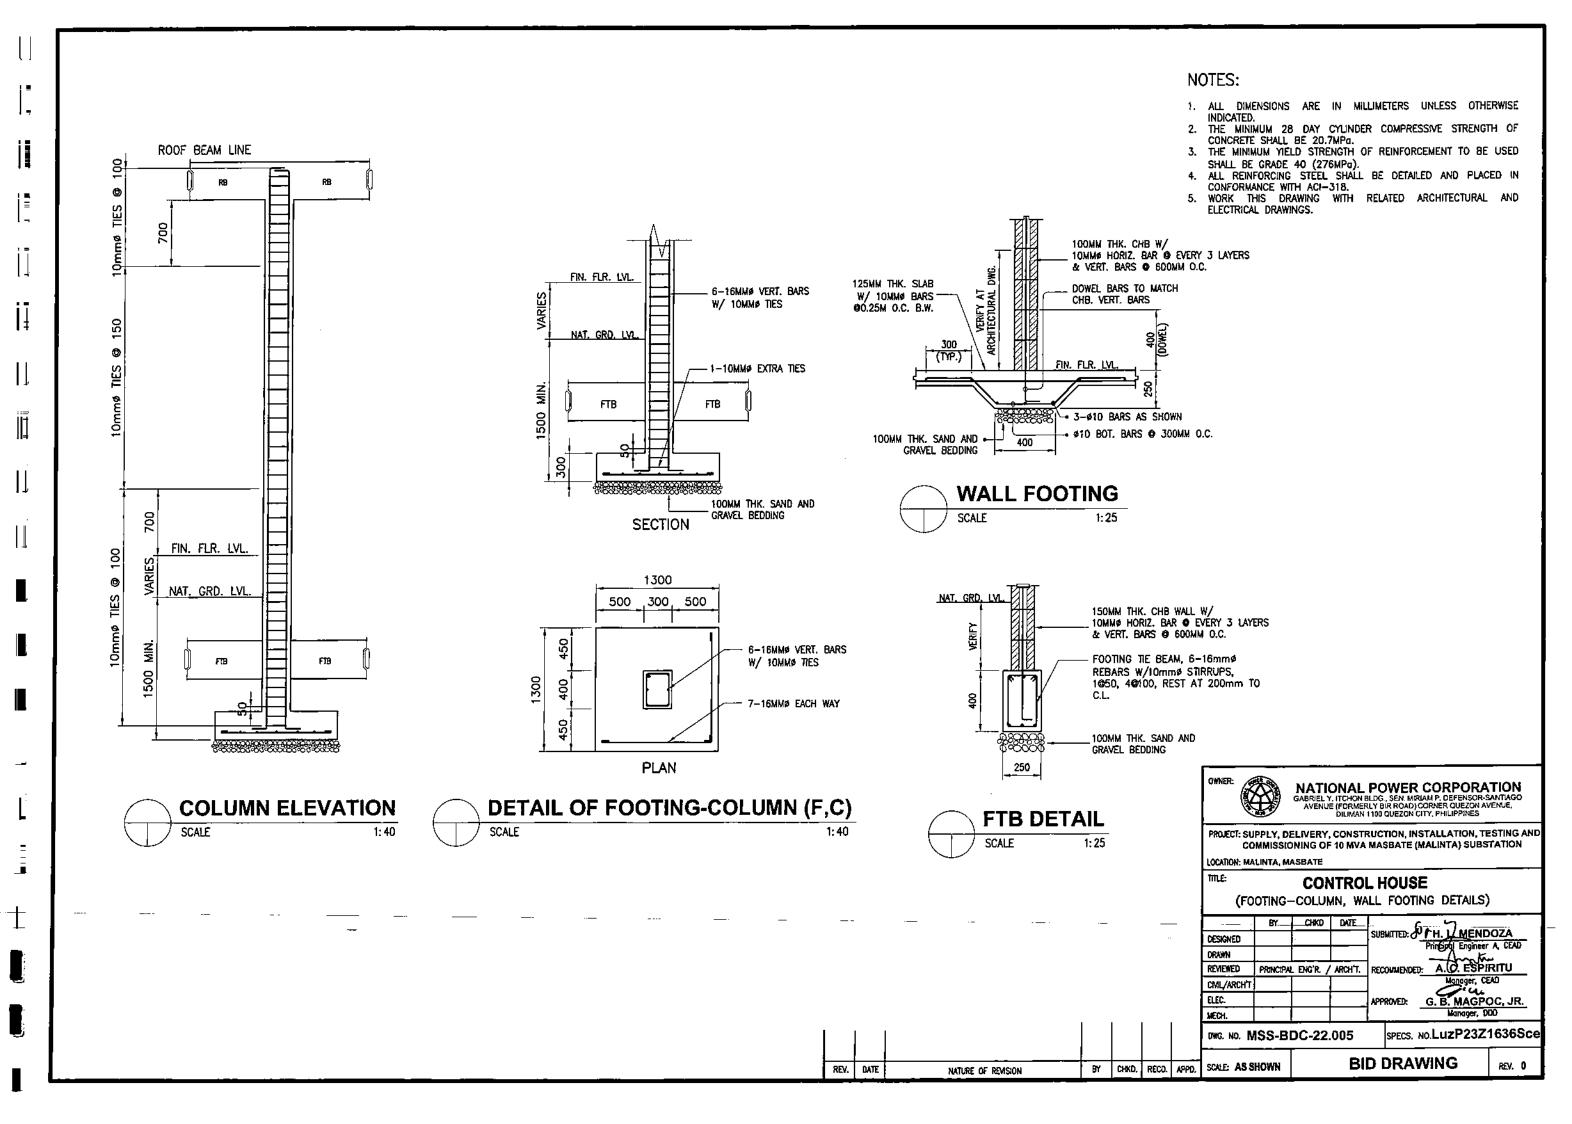


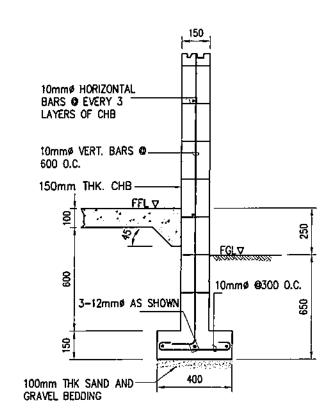




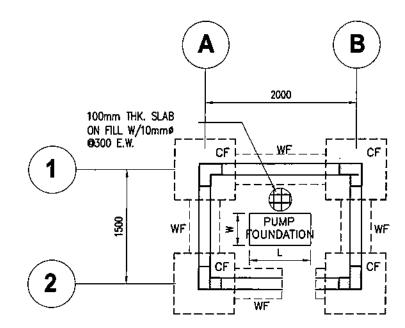



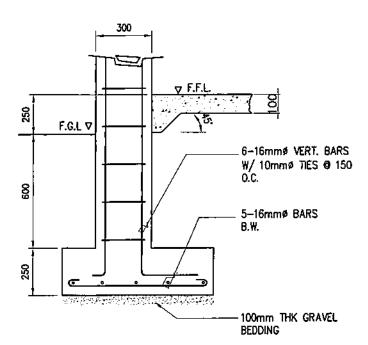




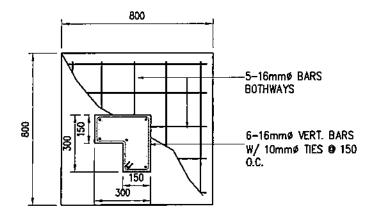

PLAN

# **COLUMN-FOOTING DETAIL (CF)**

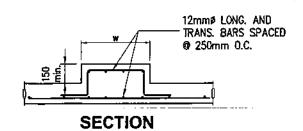



BY CHKD. RECO. APPO. REV. DATE NATURE OF REVISION

### NOTES:

- 1. MINIMUM COMPRESSIVE STRENGTH OF CONCRETE SHALL BE fc = 20.70MPa AT 28 DAYS PERIOD.
- 2. ALL REINFORCING BARS SHALL CONFORM TO THE LATEST REQUIREMENTS OF PHILIPPINE NATIONAL STANDARD FOR DSB GRADE 275.

  3. ALL ASPECTS OF CONSTRUCTION AND DETAILING OF REINFORCEMENTS
- SHALL BE IN ACCORDANCE WITH THE LATEST PROVISIONS OF ACI CODE.

  4. DIMENSION OF PUMP FOUNDATION WILL VARIES IN THE PUMP TO BE

NATIONAL POWER CORPORATION
GABRIEL Y, ITCHON BLDG., SEN. MIRIAM P. DEFENSOR-SANTIAGO
AVENUE (FORMERLY BIR ROAD) CORNER QUEZON AVENUE,
DILIMAN 1100 QUEZON CITY, PHILIPPINES

PROJECT: SUPPLY, DELIVERY, CONSTRUCTION, INSTALLATION, TESTING AND COMMISSIONING OF 10 MYA MASBATE (MALINTA) SUBSTATION

LOCATION: MALINTA, MASBATE

TITLE:

**PUMPHOUSE** (FOUNDATION PLAN, SECTION, ELEVATION & DETAILS)

	-BY	CHK0-	DATE	7
DESIGNED				SUBMITTED OF H. L. MENDOZA
DRAWN				Principal Engineer A, CEAD
REVIEWED	PRINCIPA	L ENG'R. /	ARCH'T.	RECOMMENDED: A. C. ESPIRITU
CML/ARCH'T				Wallager, CEAD
ELEC.				APPROVED: G. B. MAGPOC JR.
MECH.				Manager, DDD


DWG. NO. MSS-BDC-22,006

SPECS, NO.LUZP23Z1636Sce

SCALE: AS SHOWN

**BID DRAWING** 


REV. O

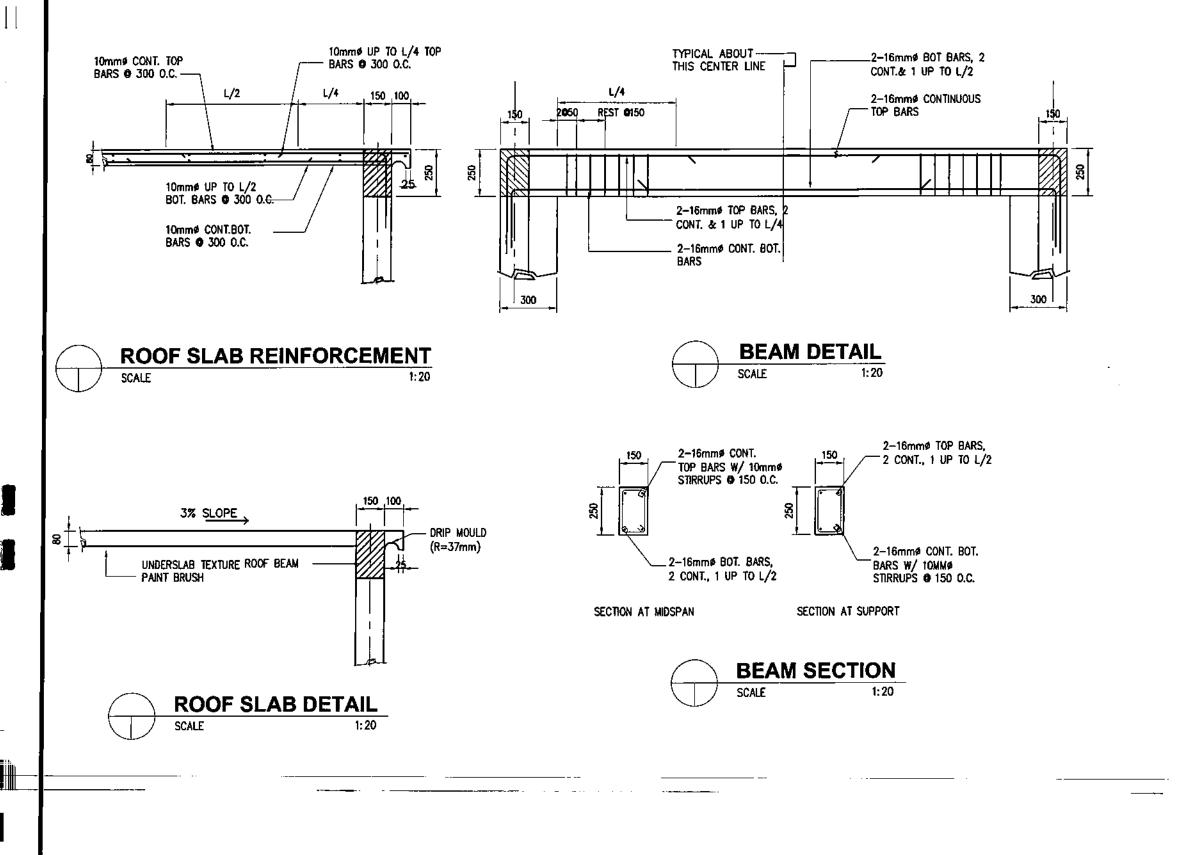



NATURE OF REVISION


#### NOTES:


- 1. ALL DIMENSION ARE IN MILLIMETERS UNLESS OTHERWISE INDICATED.
- 2. MINIMUM COMPRESSIVE STRENGTH OF CONCRETE SHALL BE fc = 20.70 MPa AT 28-DAYS PERIOD.
- 3. REINFORCING STEEL BARS SHALL CONFORM TO THE LATEST REQUIREMENTS OF PNS FOR DEFORMED STEEL BARS GRADE 275
- 4. ALL ASPECTS OF CONSTRUCTION AND DETAILING OF REINFORCEMENTS SHALL BE IN ACCORDANCE WITH THE LATEST PROVISIONS OF ACI CODE.

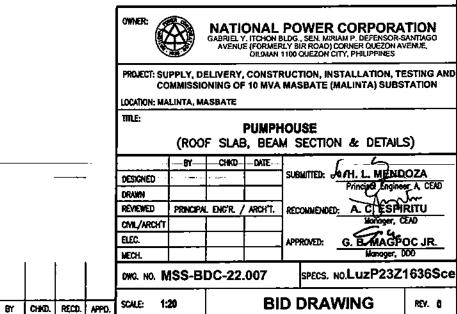


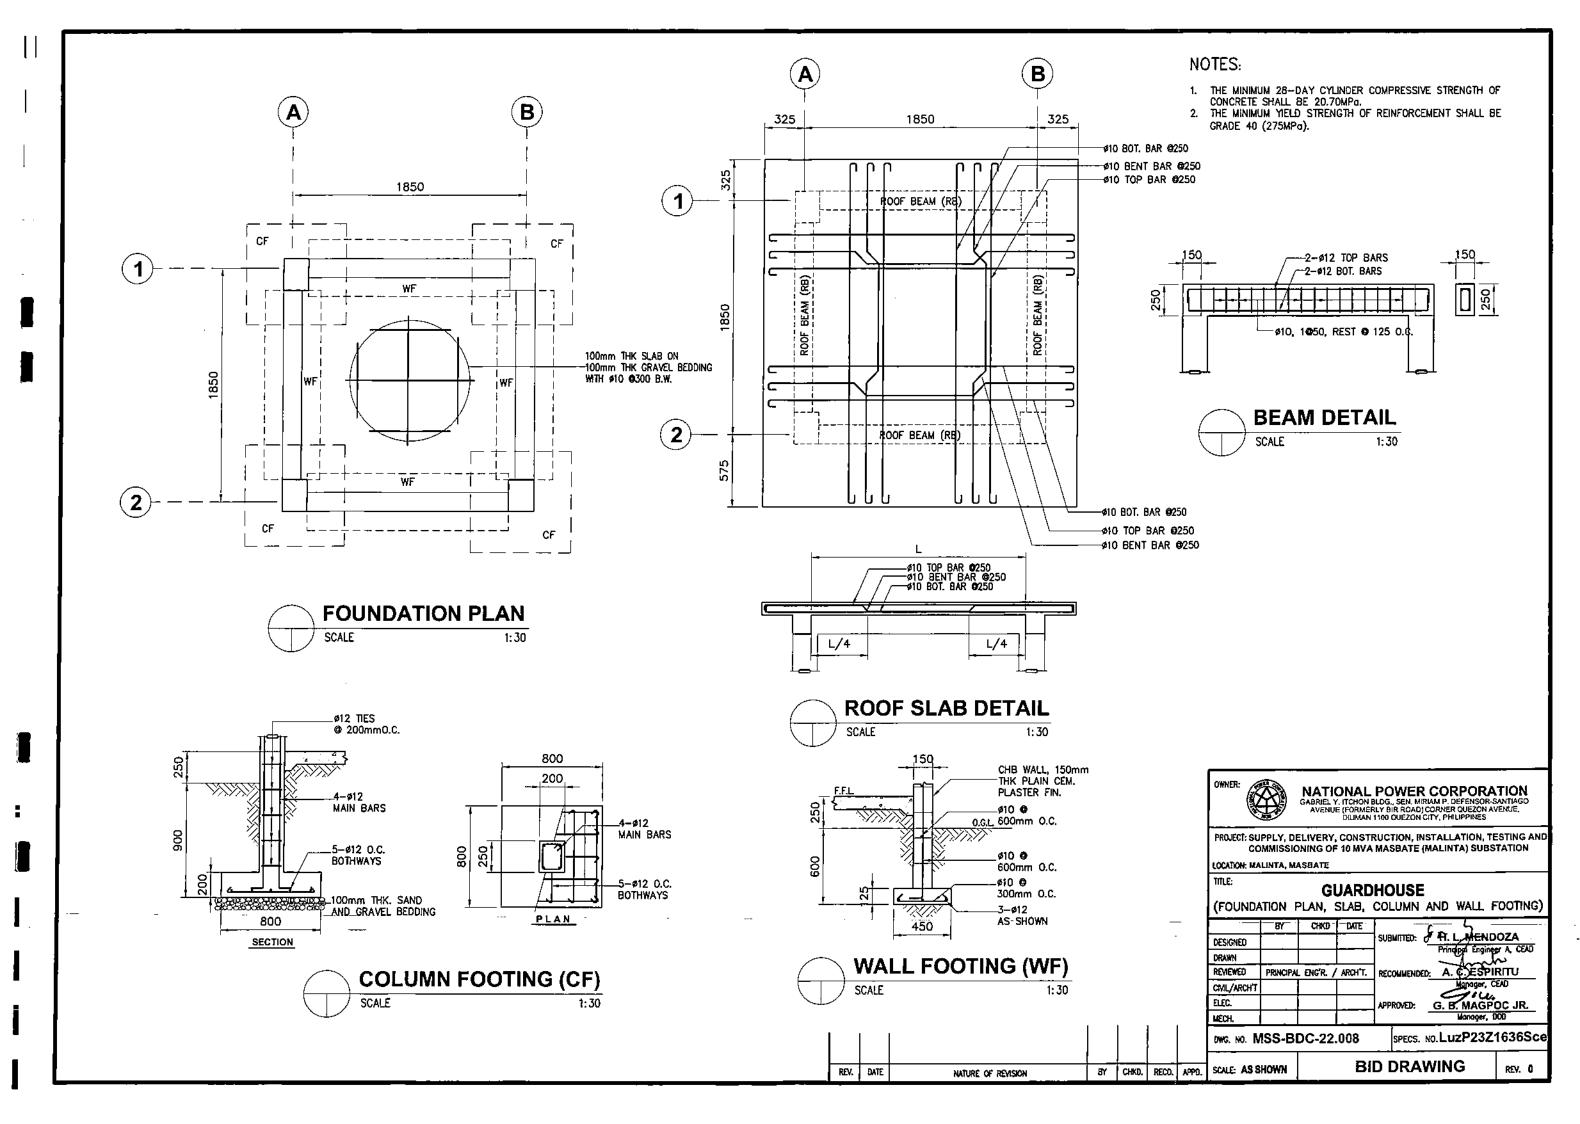


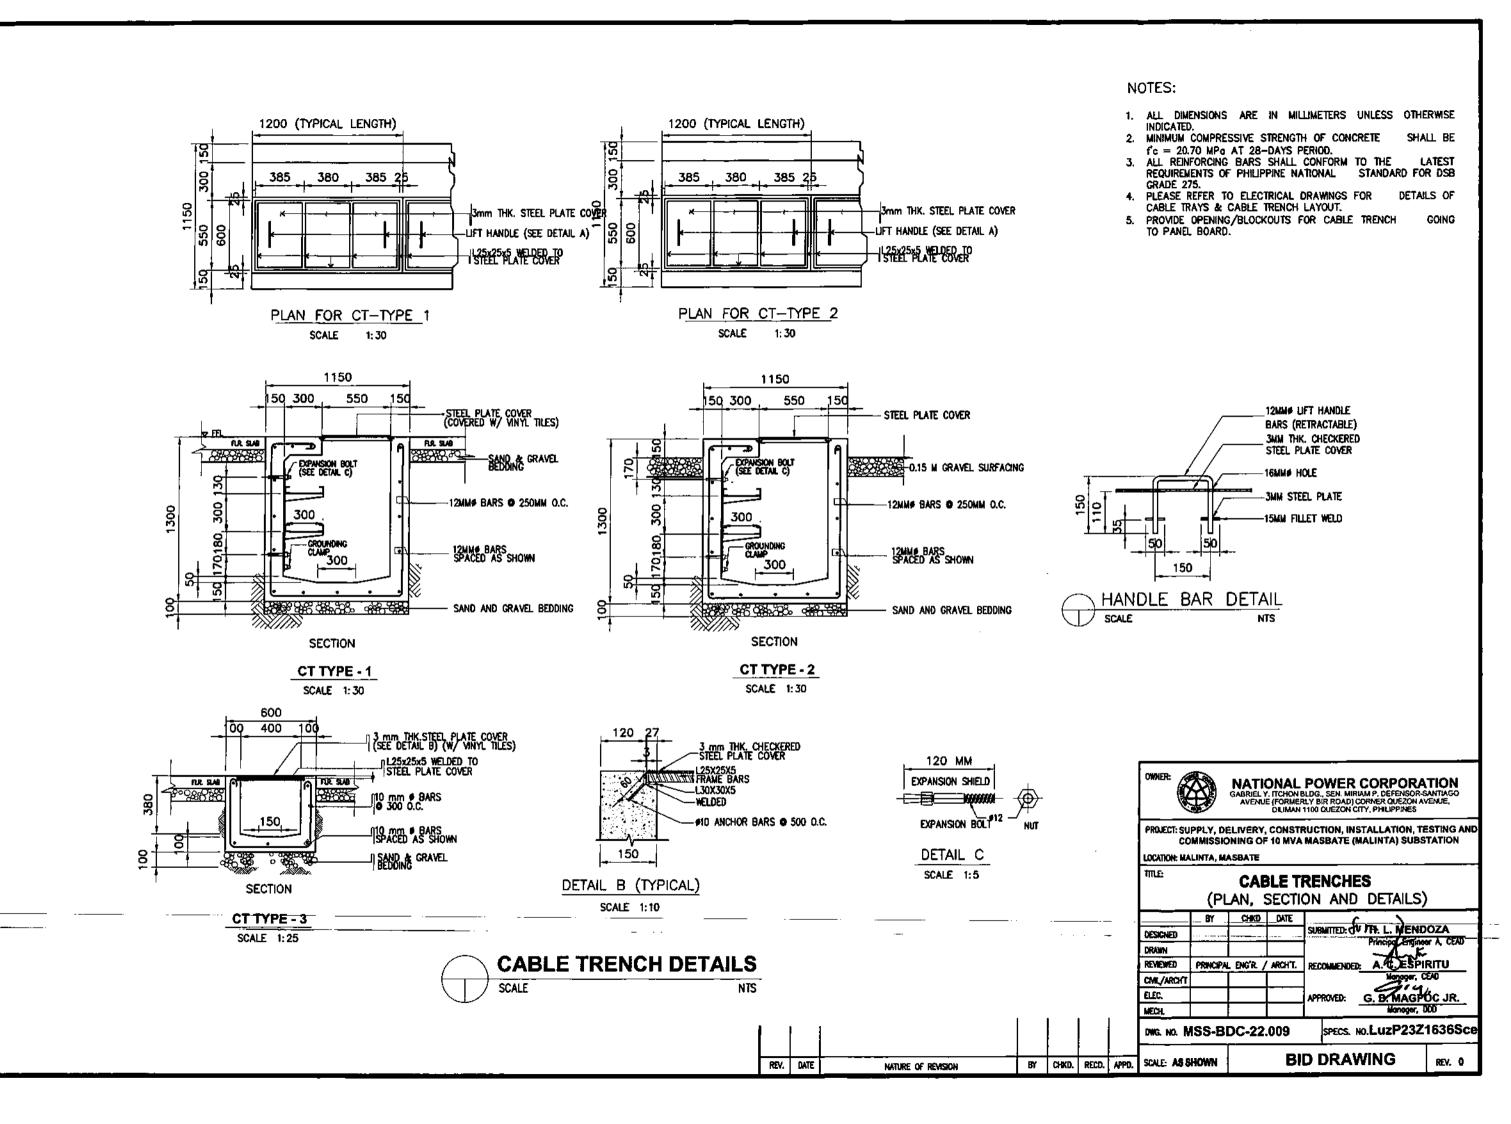


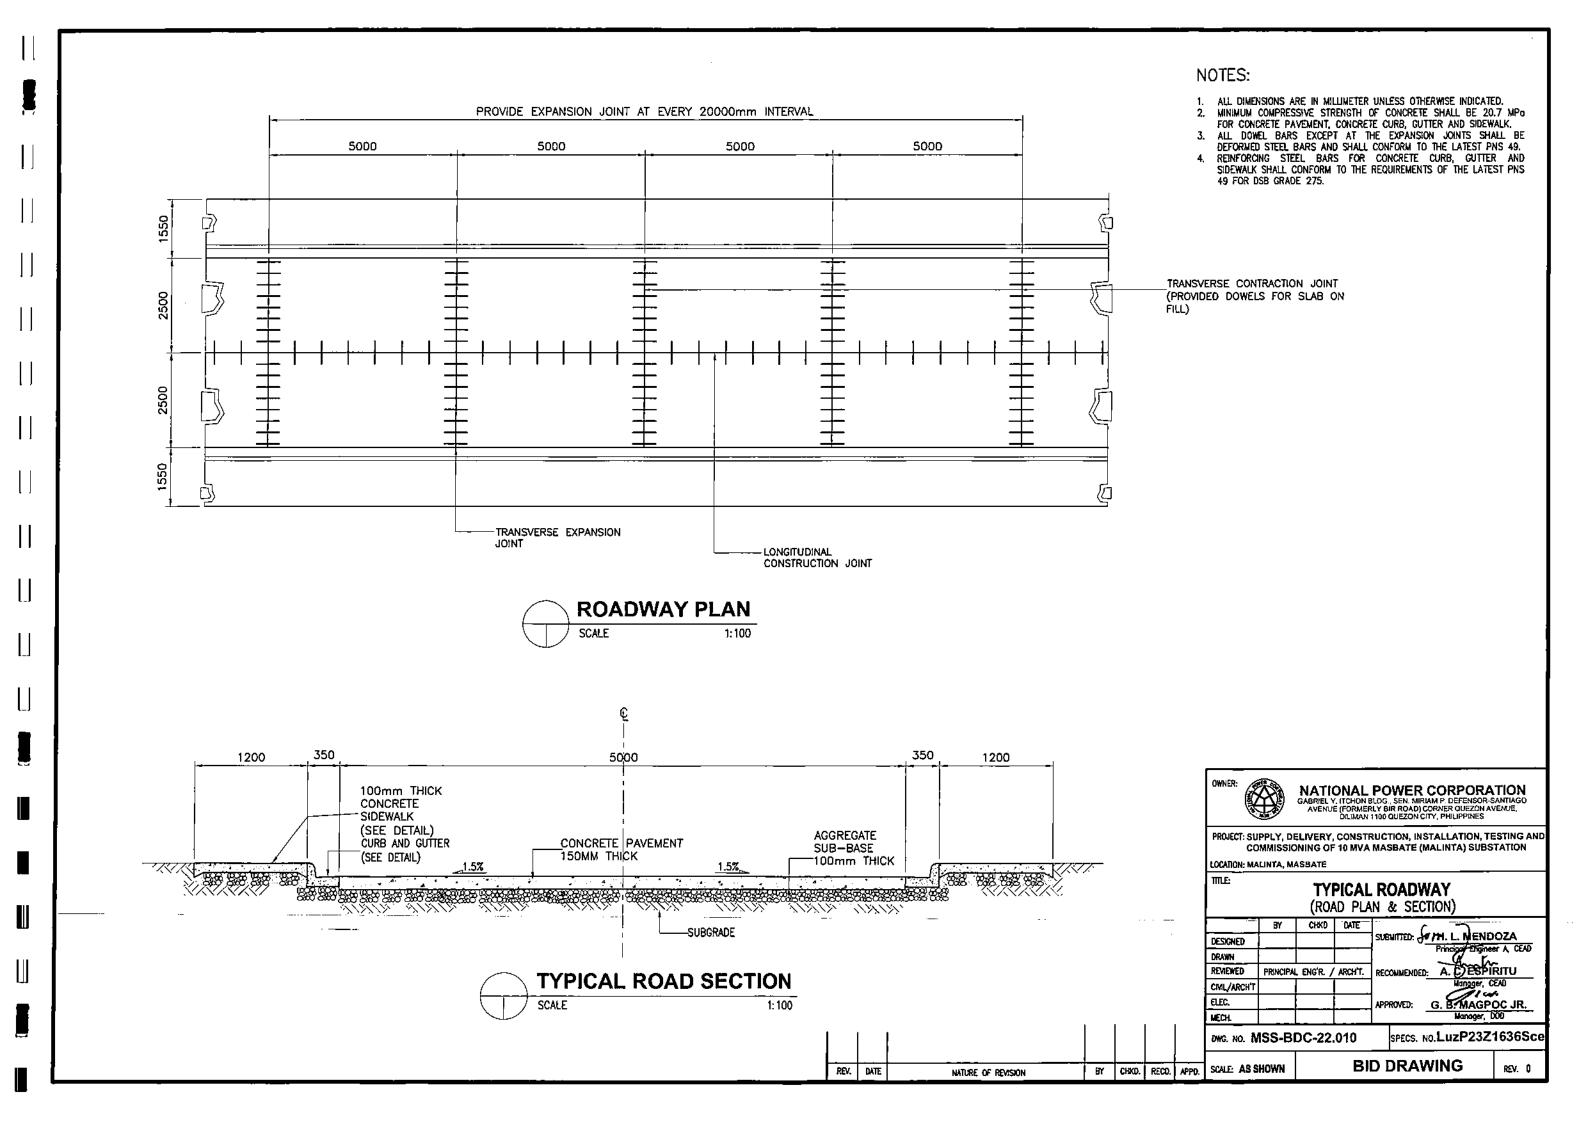


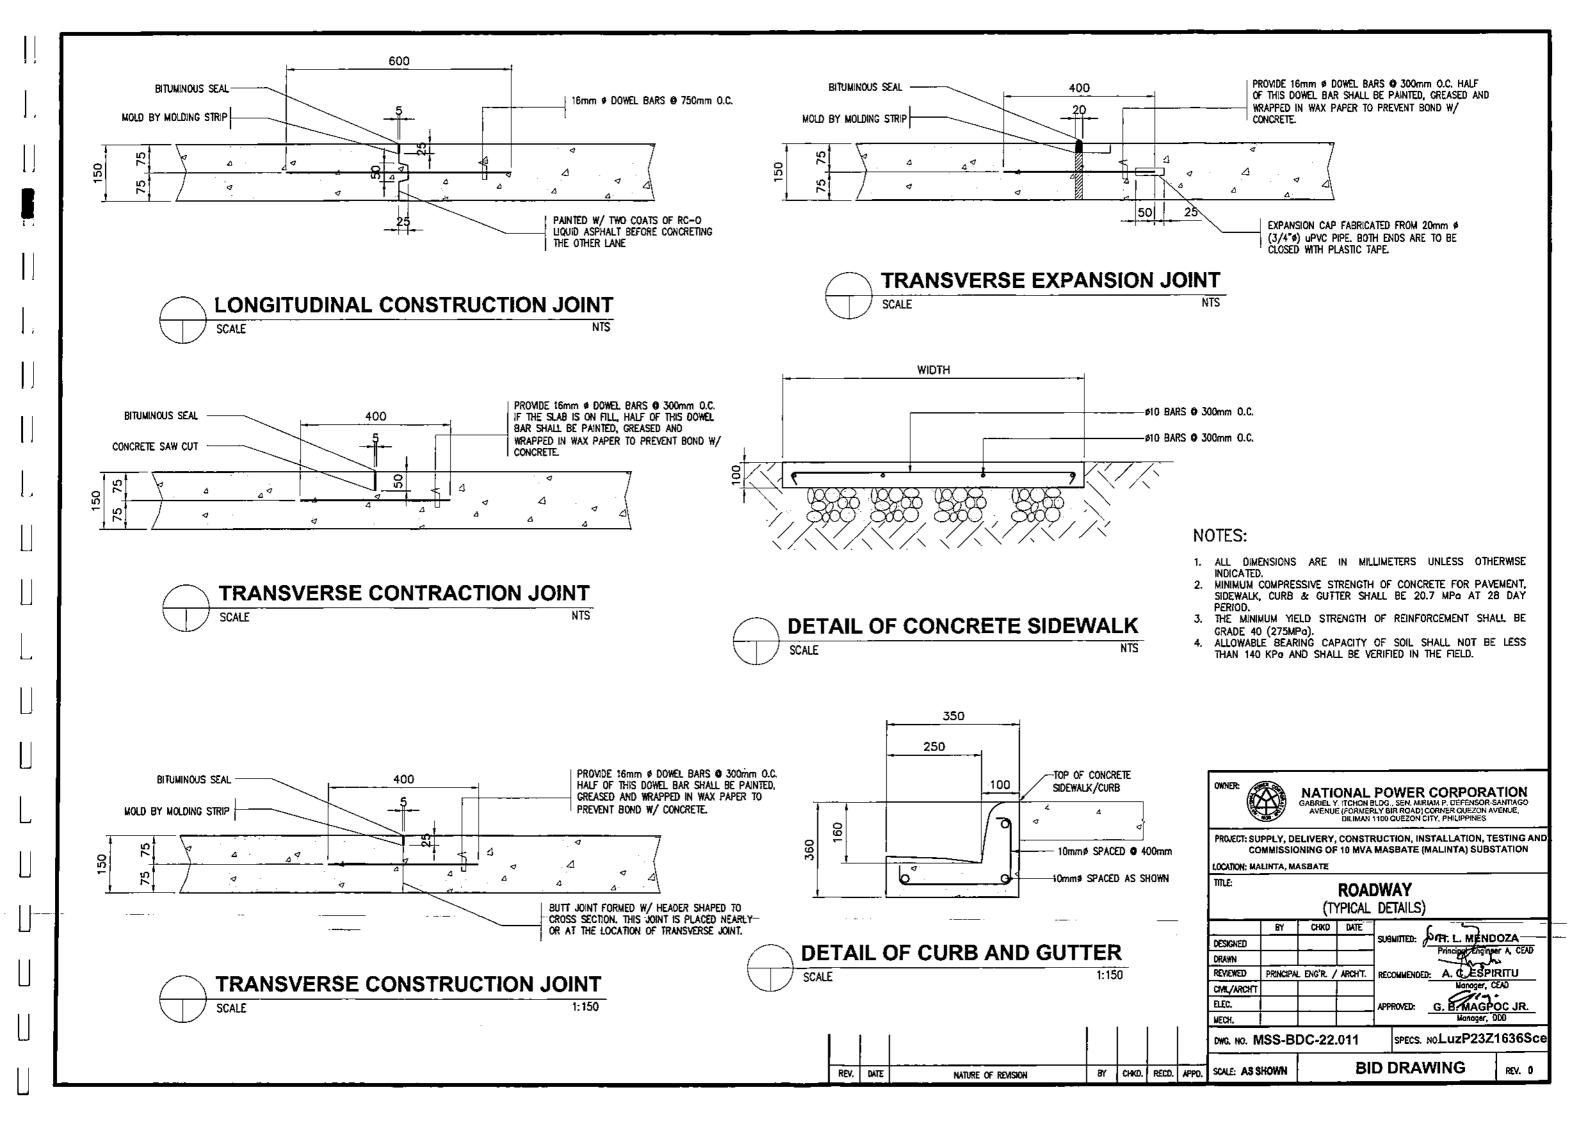


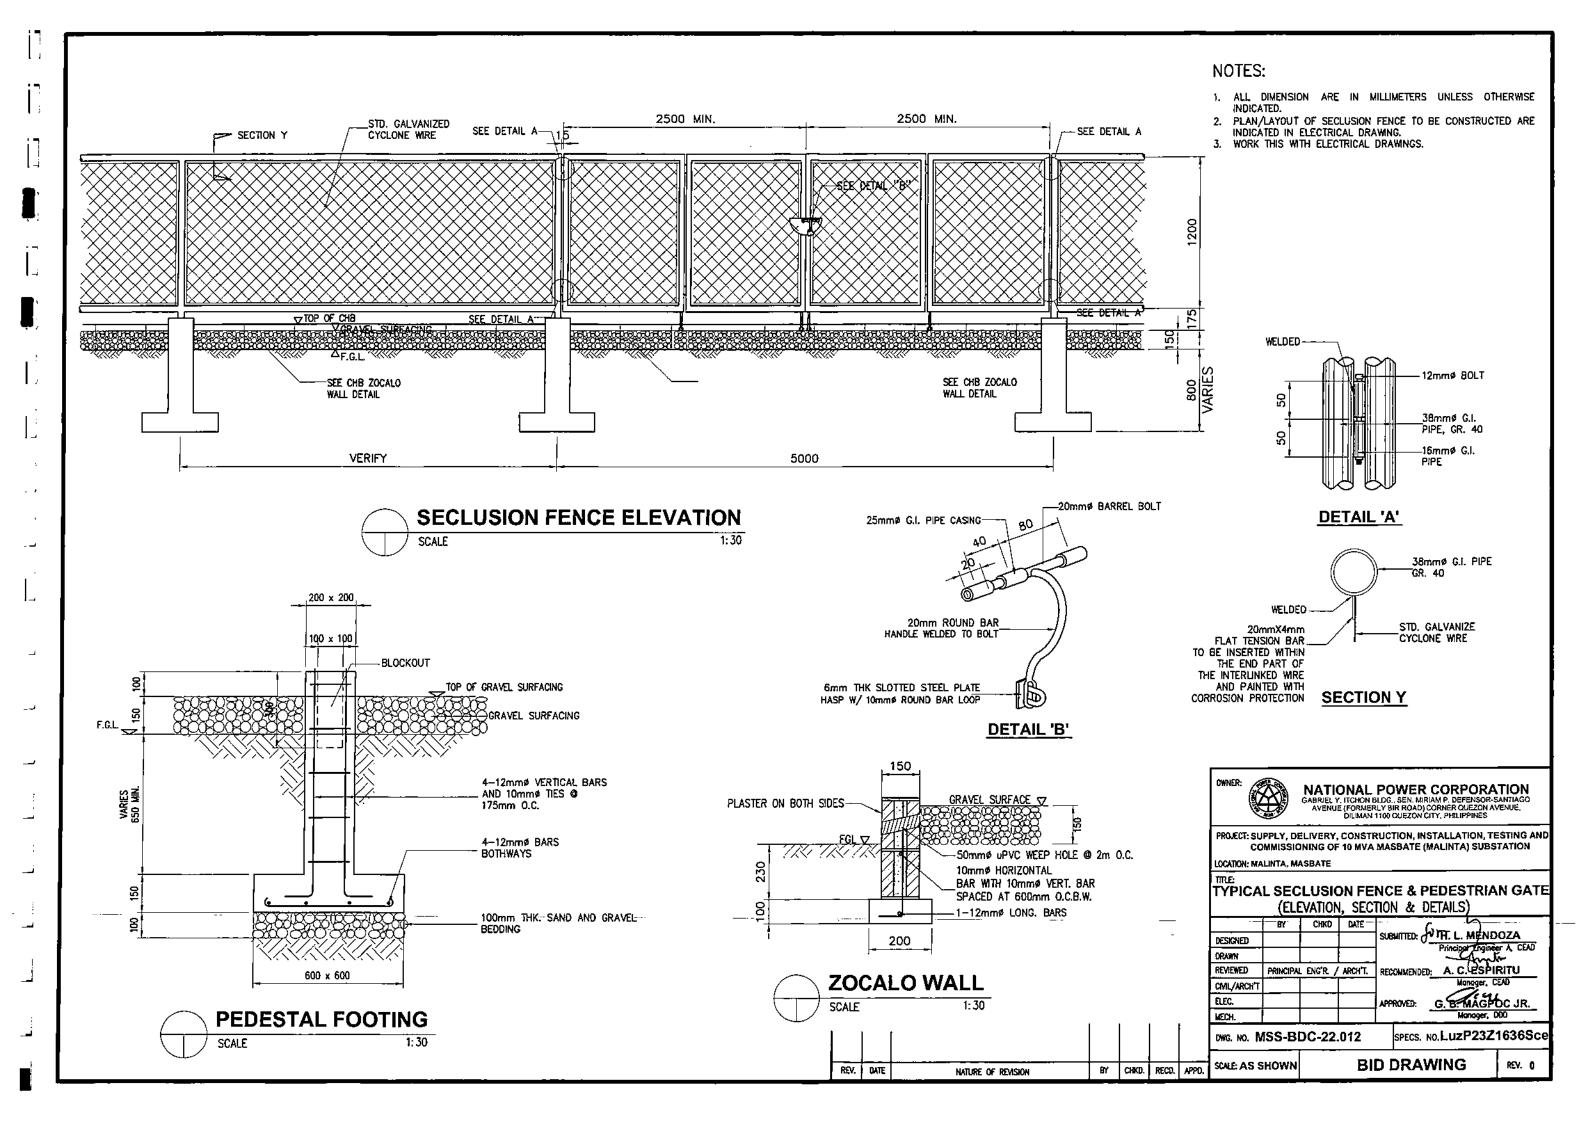


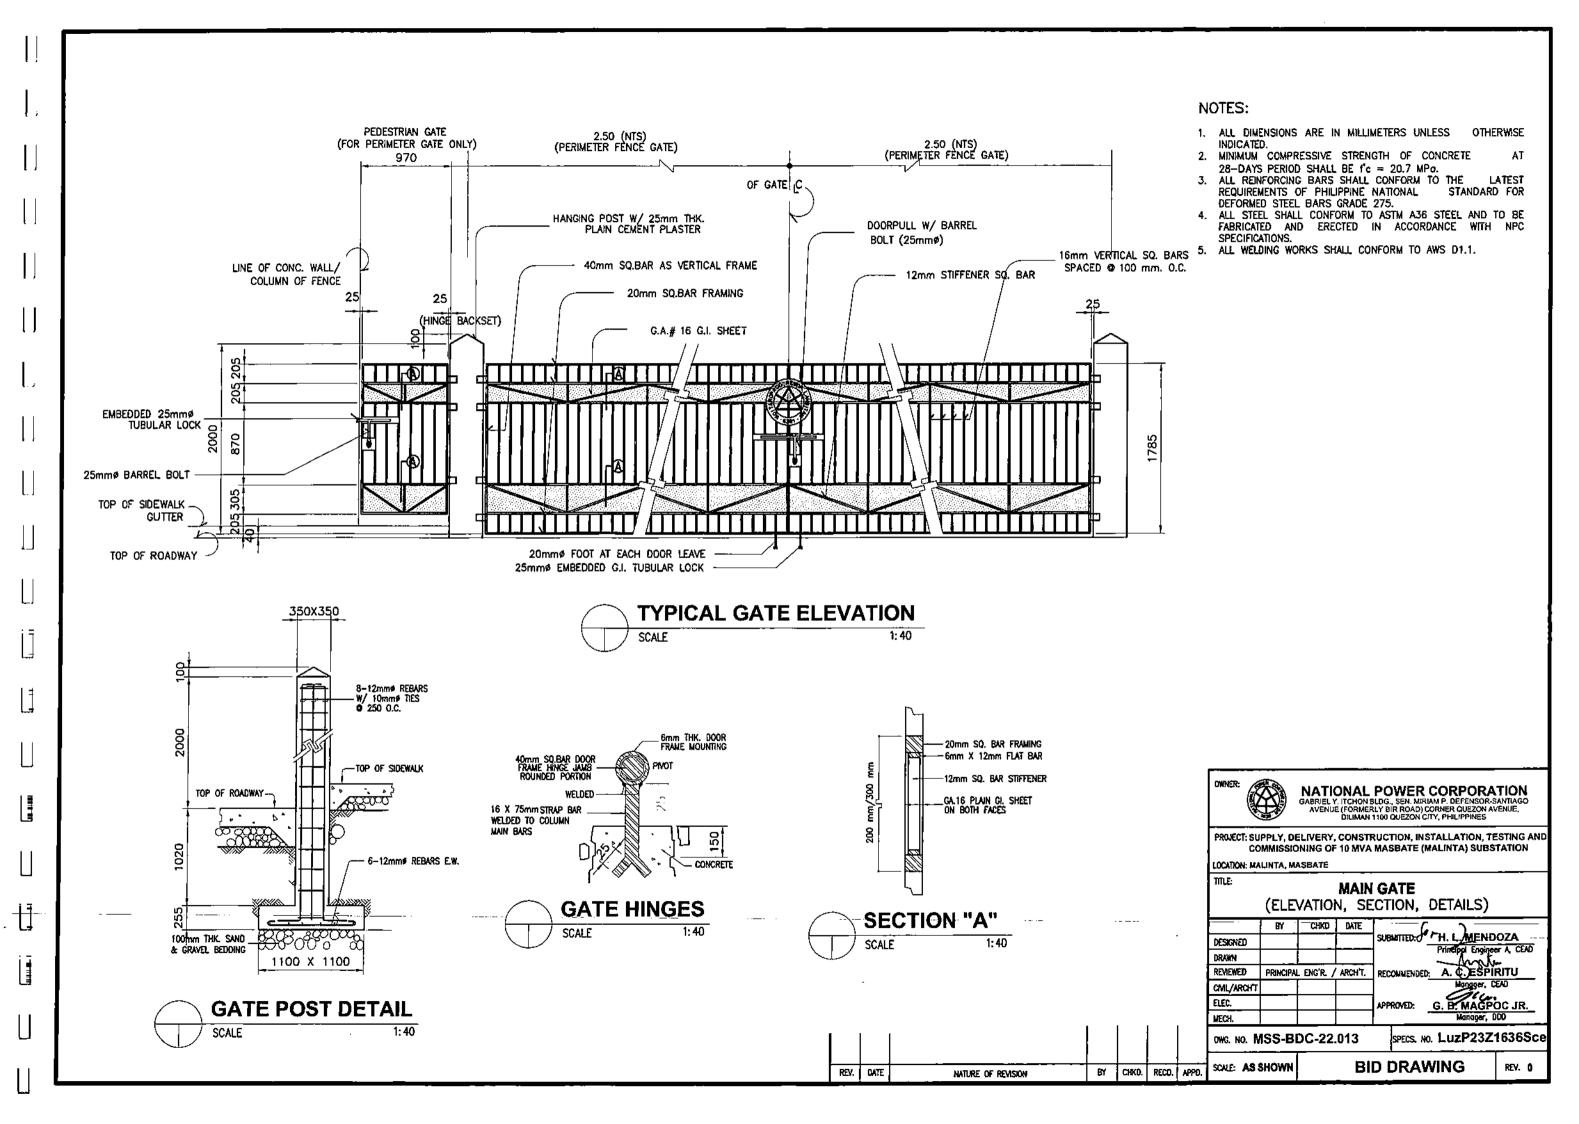


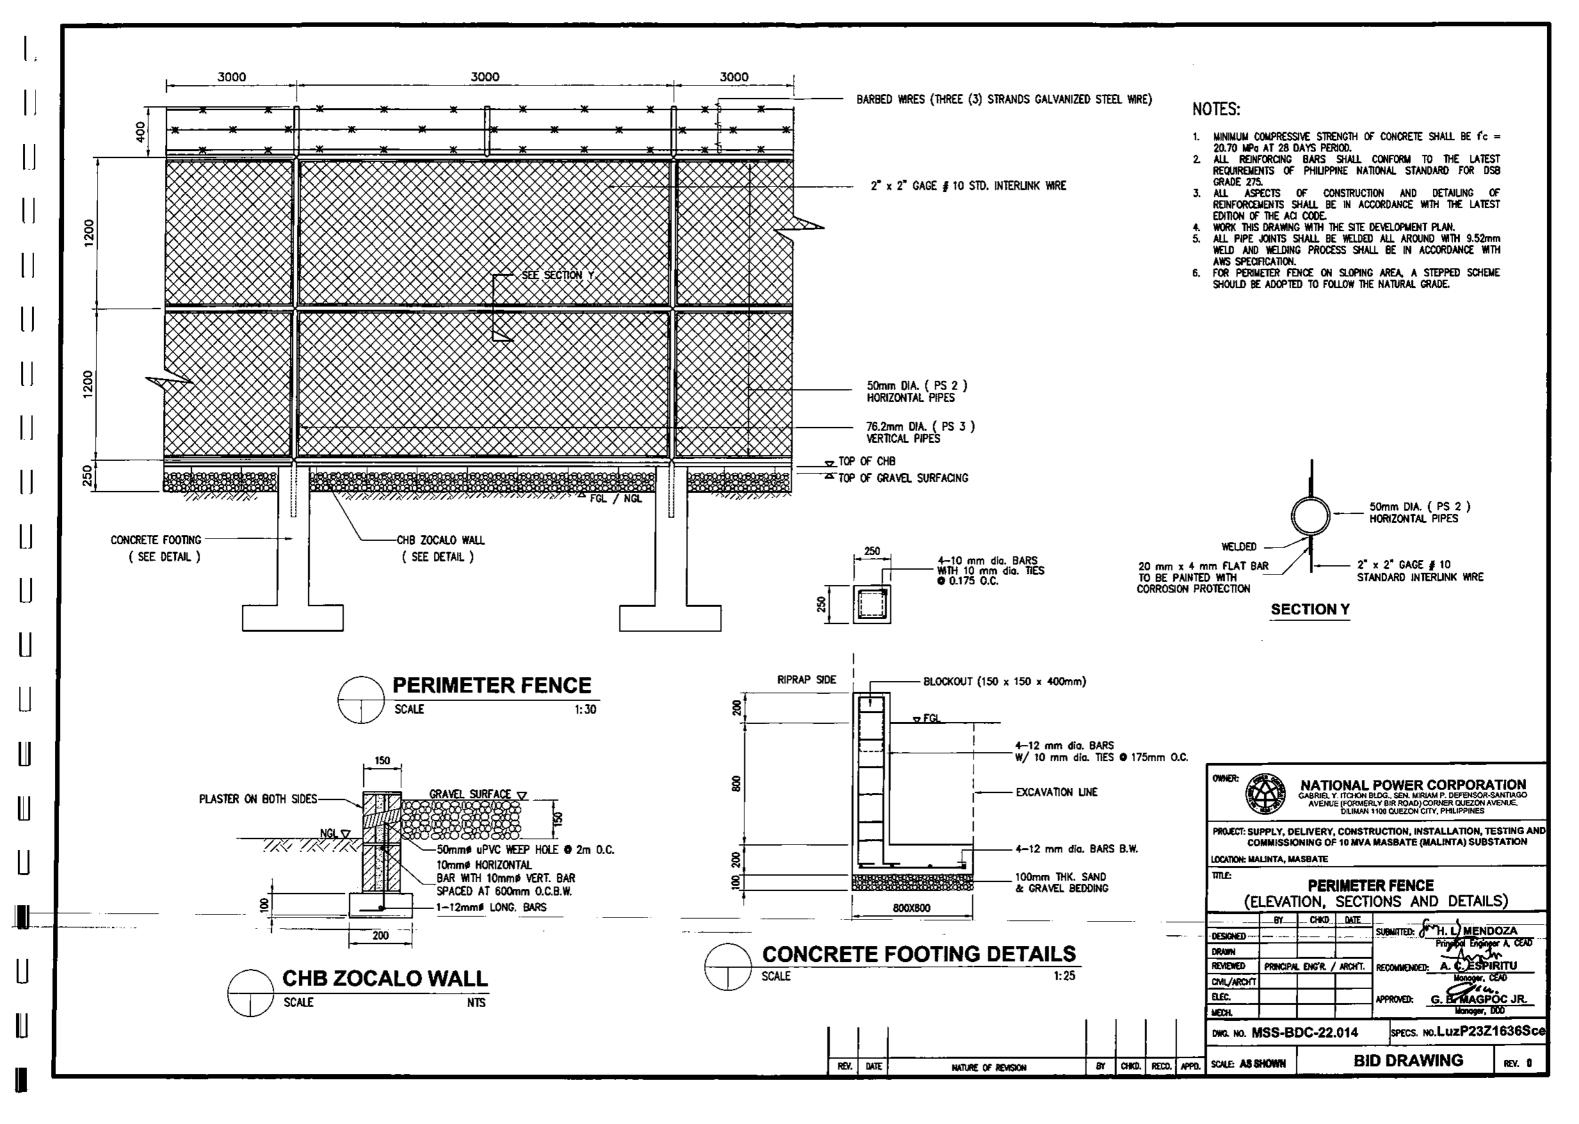

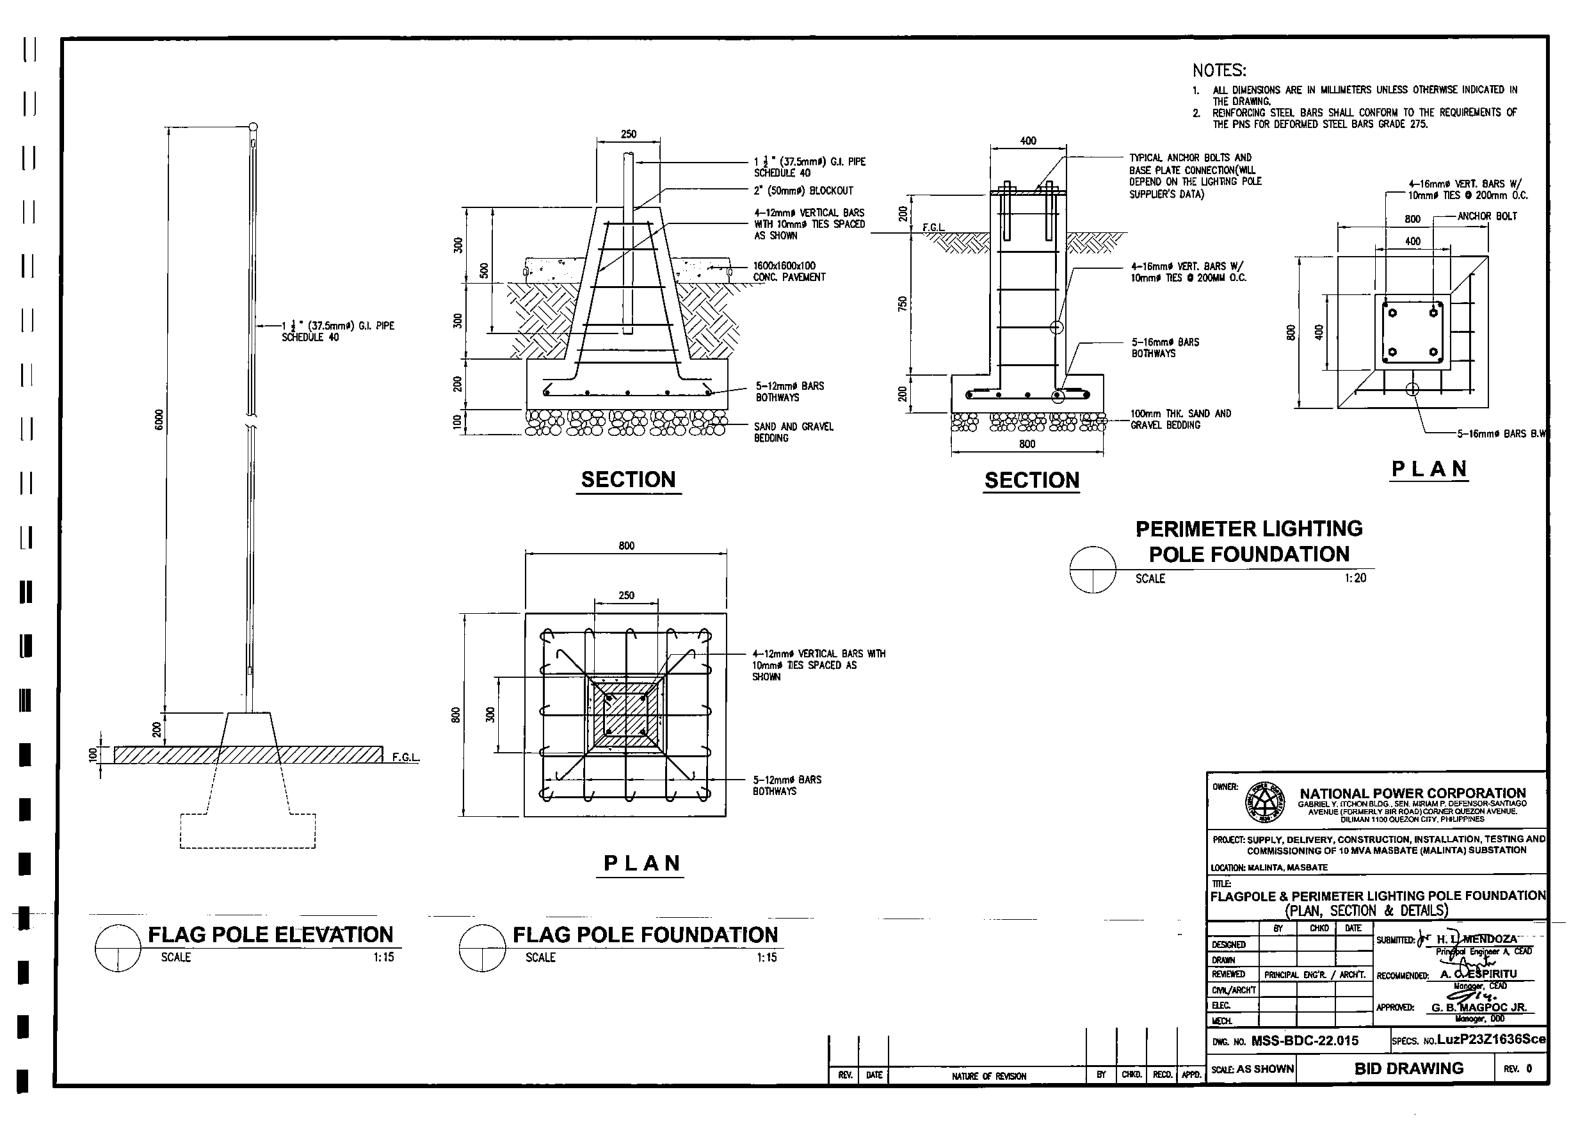

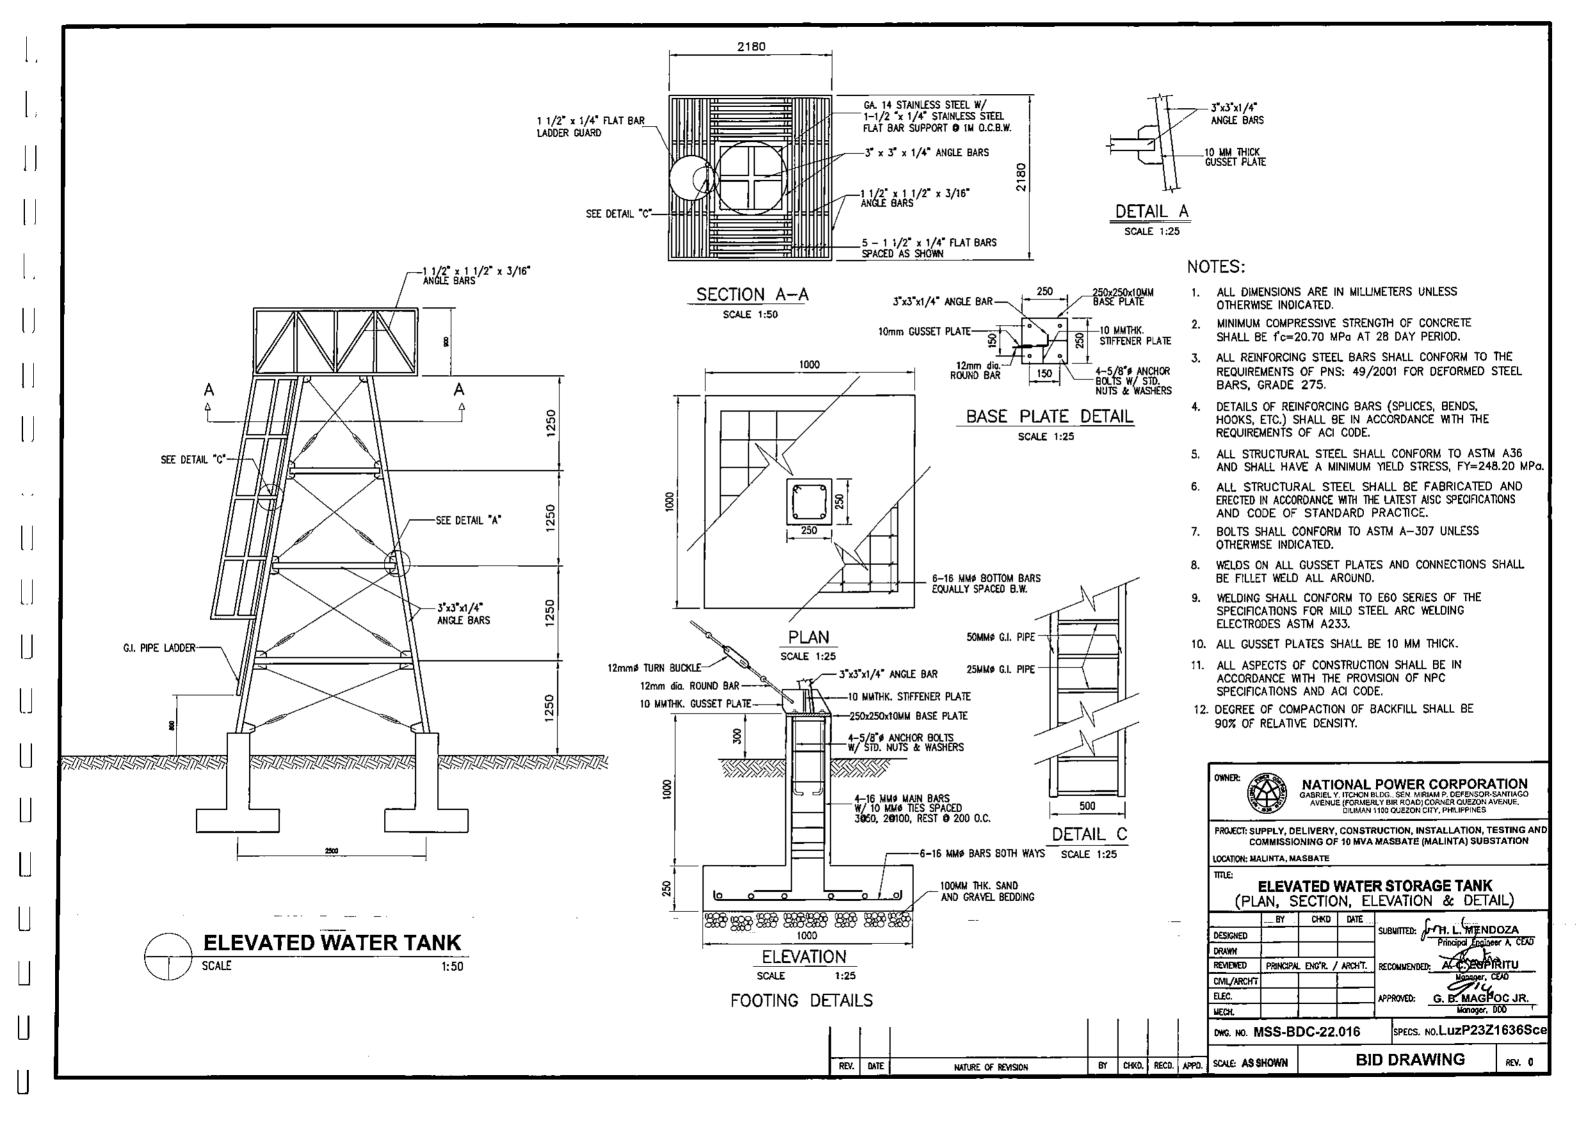

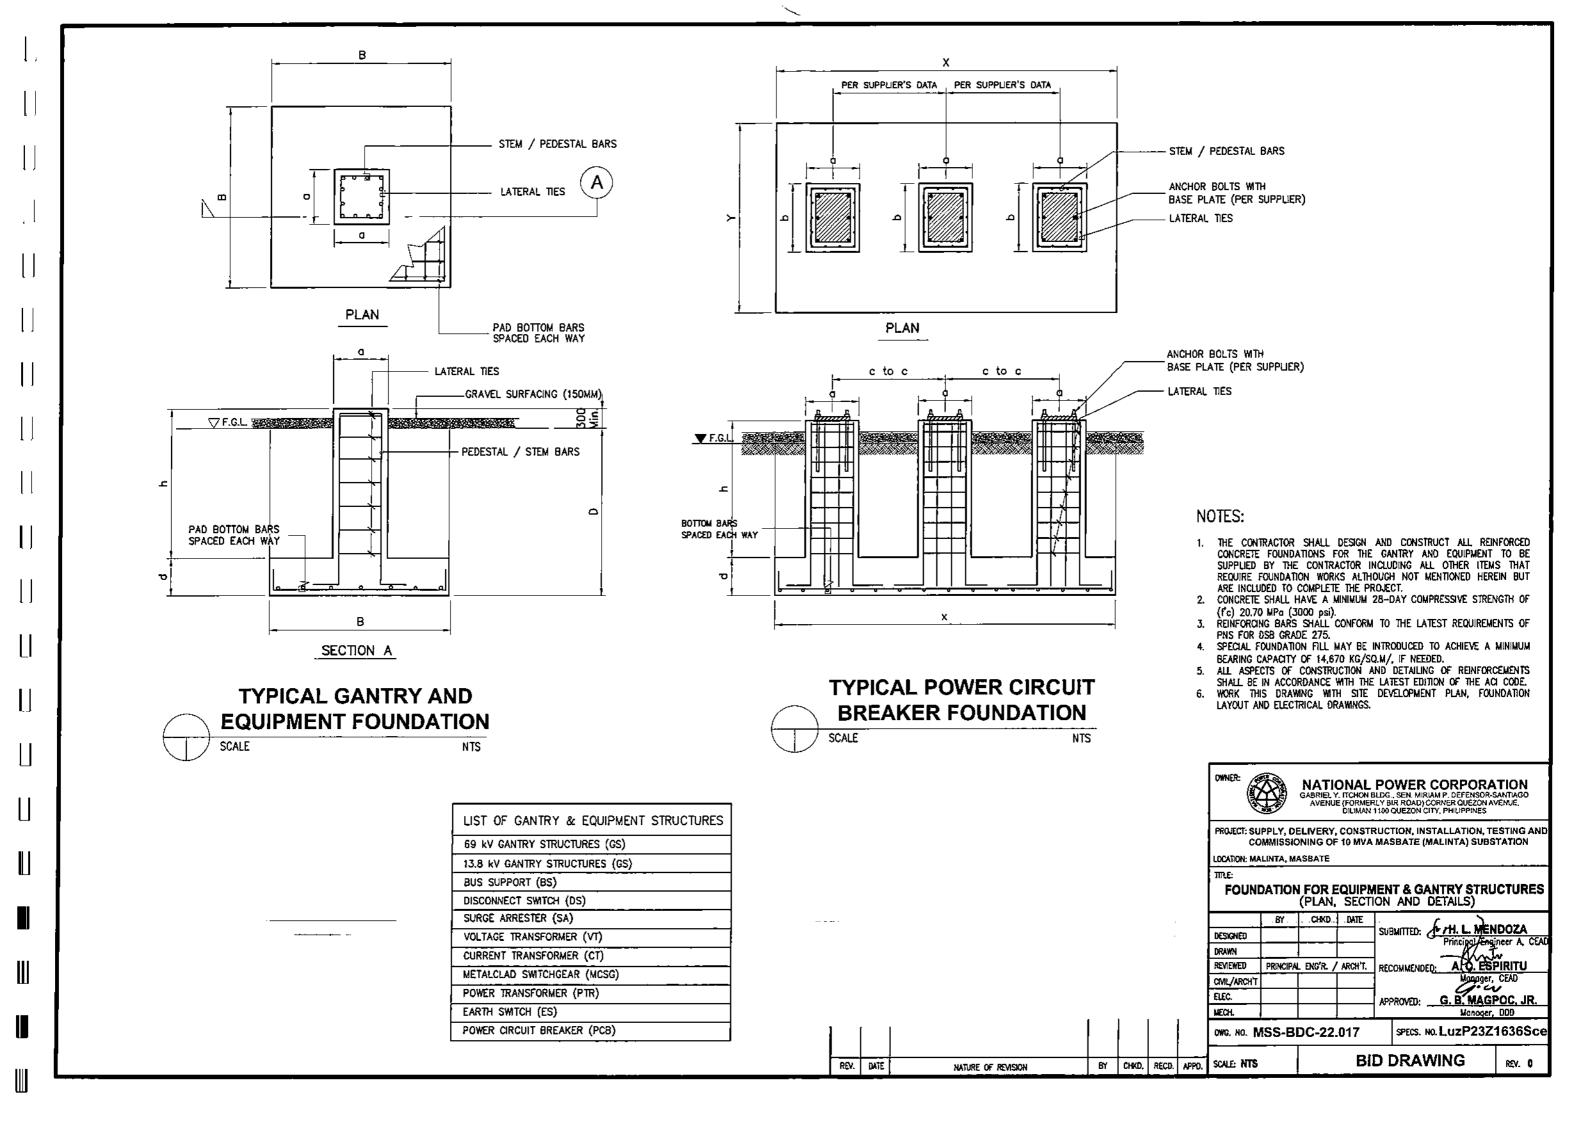

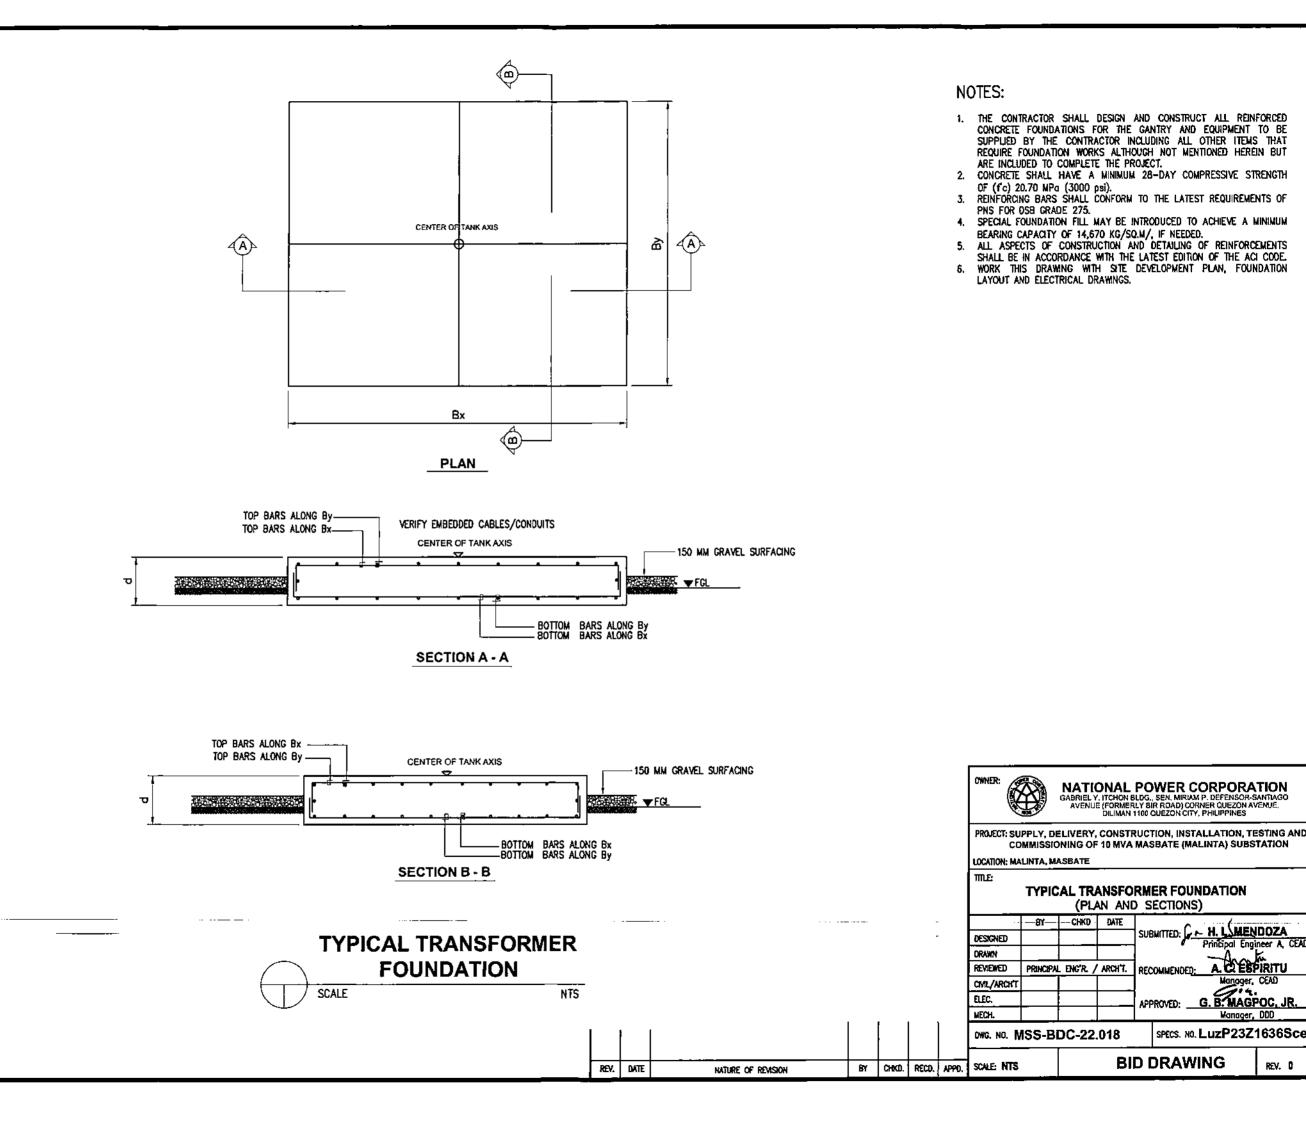


Principal Engineer A, CEAD

A. CLESPIRITU

Manager, CEAD G. B. MAGPOC, JR.


Manager, DDD SPECS. NO. LuzP23Z1636Sce

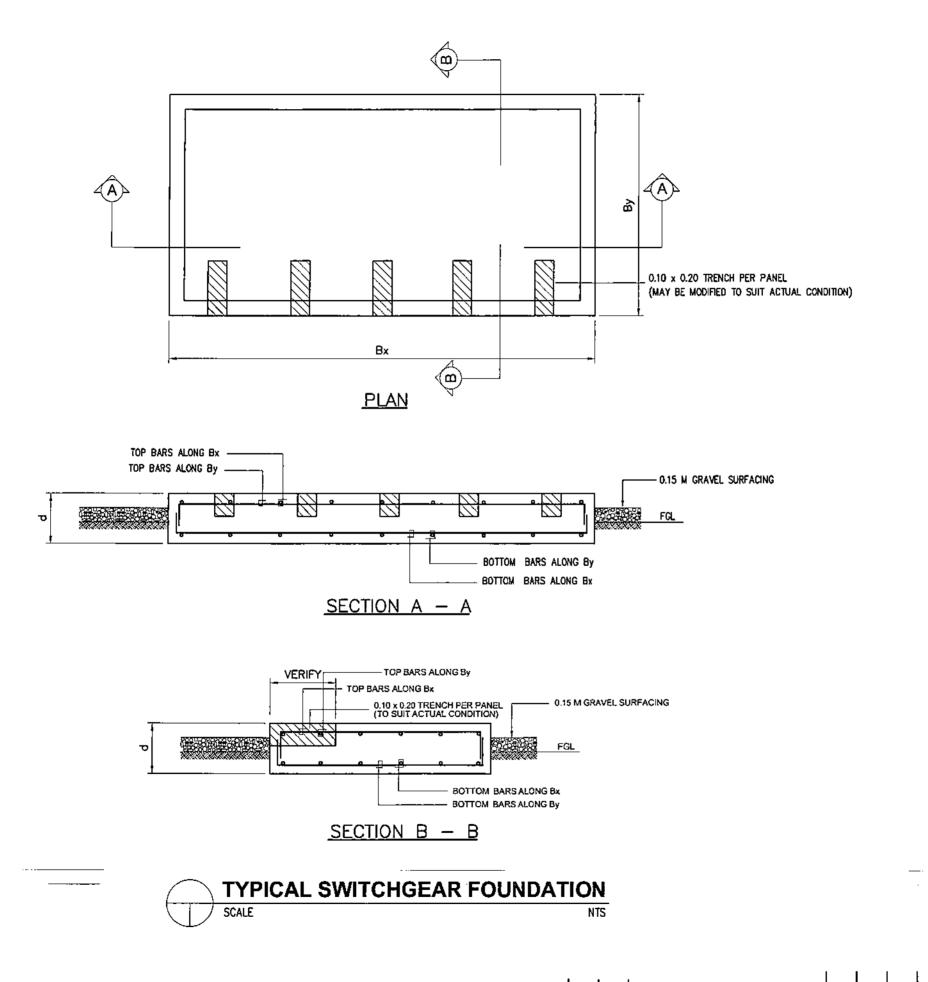

NATURE OF REVISION

#### NOTES:

- 1. ALL DIMENSIONS ARE IN MILLIMETERS UNLESS OTHERWISE SPECIFIED.
- 2. THE CONTRACTOR SHALL DESIGN AND CONSTRUCT ALL REINFORCED CONCRETE FOUNDATIONS FOR THE GANTRY AND EQUIPMENT TO BE SUPPLIED BY THE CONTRACTOR INCLUDING ALL OTHER ITEMS THAT REQUIRE FOUNDATION WORKS ALTHOUGH NOT MENTIONED HEREIN BUT ARE INCLUDED TO COMPLETE THE PROJECT.
- 3. CONCRETE SHALL HAVE A MINIMUM 28-DAY COMPRESSIVE STRENGTH OF 20.7 MPa (3000 PSI).
- 4. REINFORCING BARS SHALL CONFORM TO THE LATEST REQUIREMENTS OF PNS FOR DSB GRADE 275.
- 5. SPECIAL FOUNDATION FILL MAY BE INTRODUCED TO ACHIEVE A MINIMUM BEARING CAPACITY OF 144 KPg, IF NEEDED.
- 6. USE HORIZONTAL PEAK GROUND ACCELERATION OF 0.35G IN DESIGN.
- 7. USE 260KPH WIND VELOCITY IN DESIGN.
- ALL ASPECTS OF DESIGN, DETAILING AND CONSTRUCTION OF REINFORCEMENTS SHALL BE IN ACCORDANCE WITH THE LATEST EDITION OF THE ACI CODE.
- 9. WORK THIS DRAWING WITH SITE DEVELOPMENT PLAN, FOUNDATION LAYOUT AND ELECTRICAL DRAWINGS.

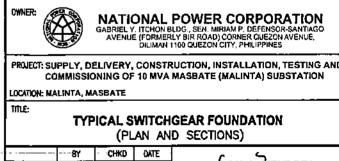

SUBMITTED: JAMENDOZA DESIGNED Principal Engineer A, CEAD
RECOMMENDED: A. C. ESPIRITU DRAWN REVIEWED PRINCIPAL ENG'R. / ARCH'T. Monager, CEAD CML/ARCHT G. B. MAGPOC JR. ELEC. MECH.

DWG. NO. MSS-BDC-22.019


SPECS. NO.LUZP23Z1636Sce


REV. 0

SCALE: NTS

BY CHKD. RECD. APPO.

**BID DRAWING** 

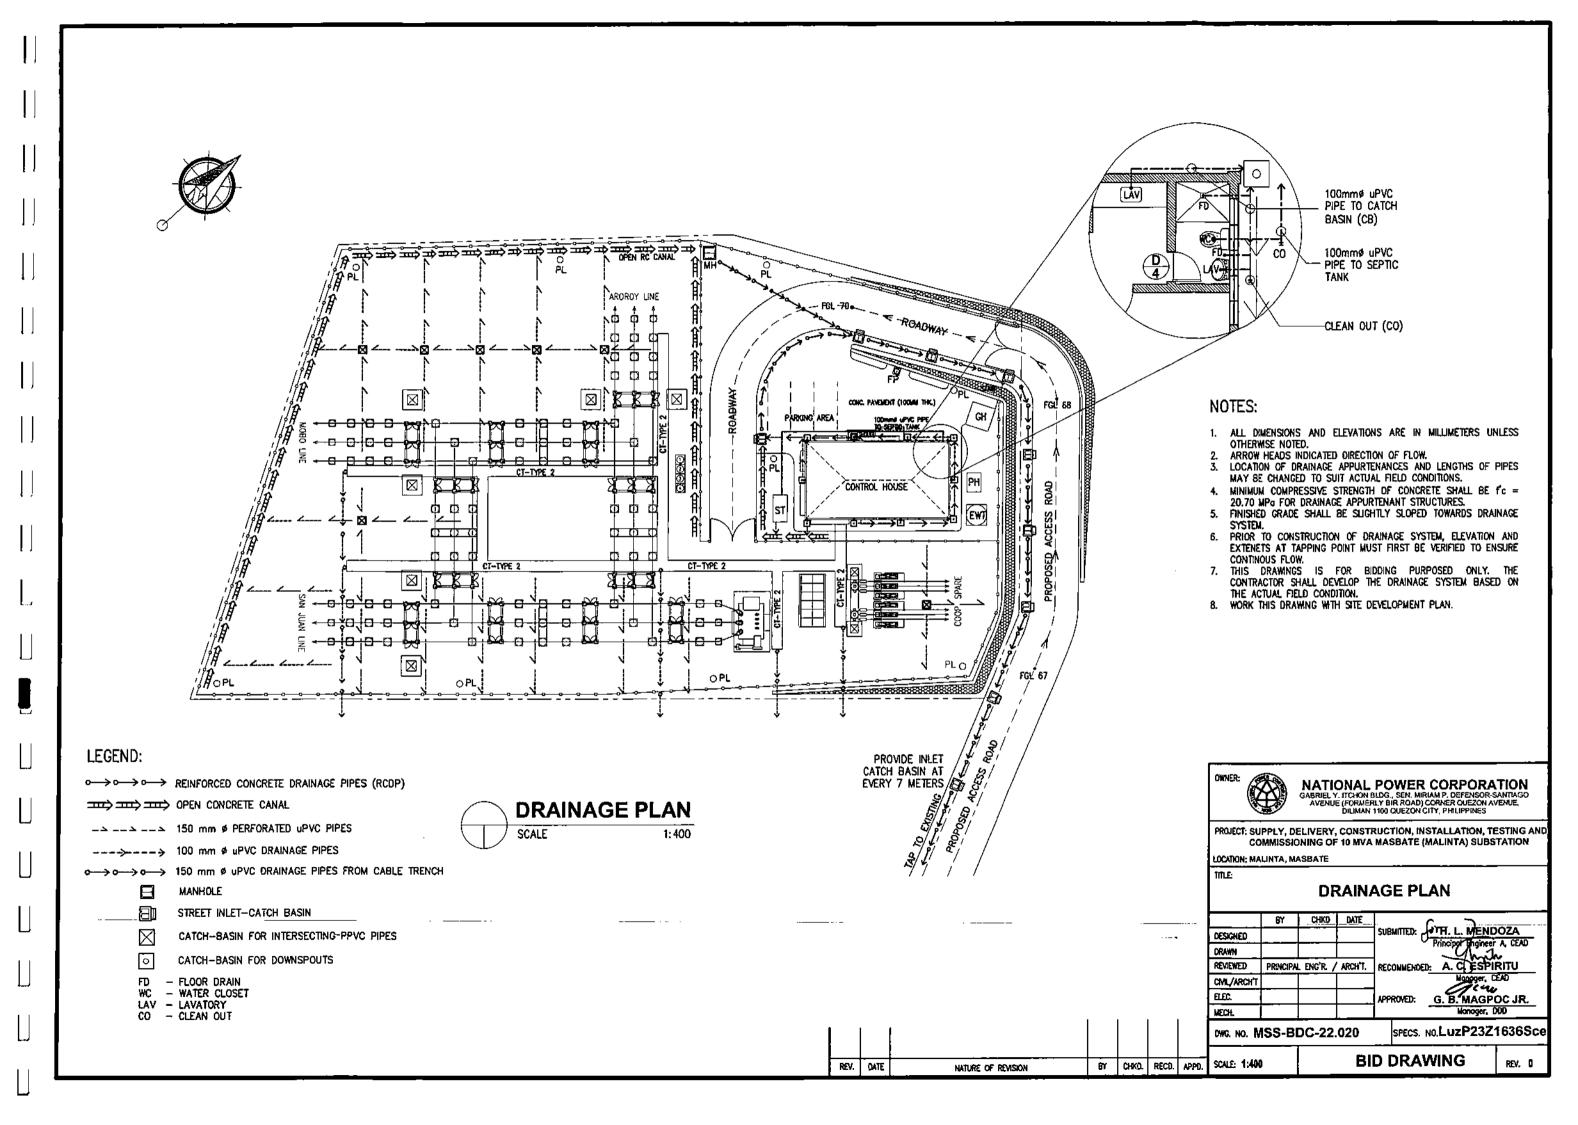

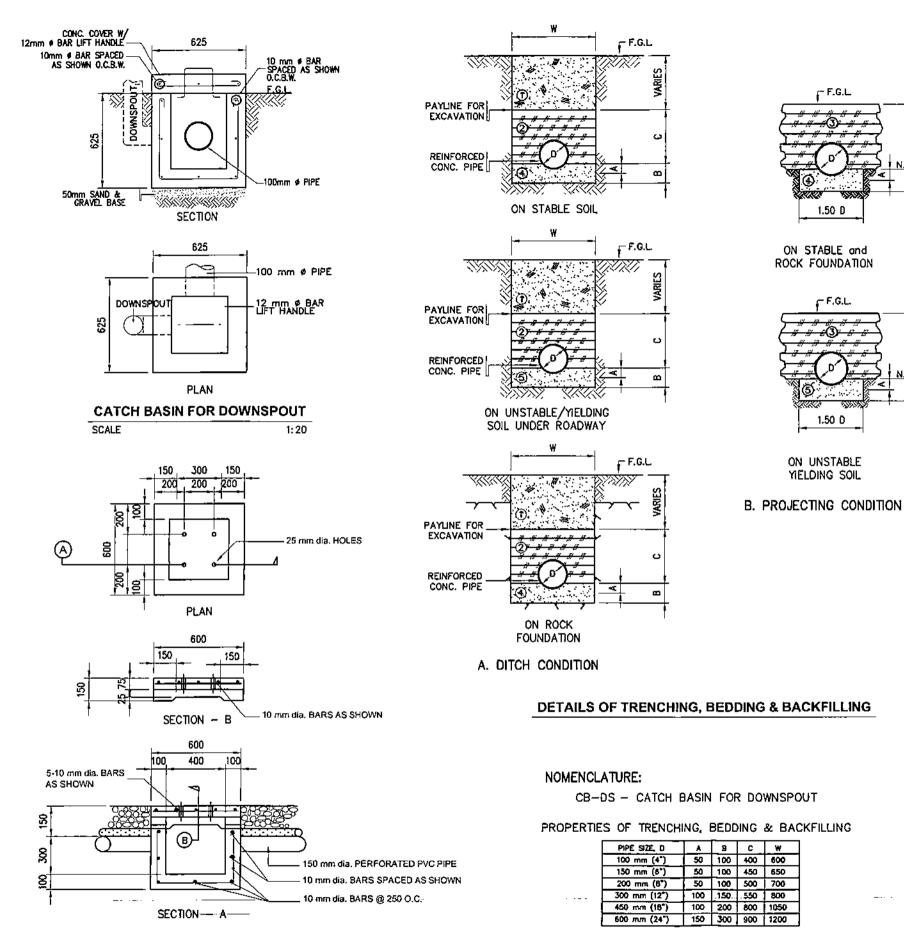

1: 25

#### TYPICAL CATCH BASIN FOR INTERSECTING PVC PIPES

SCALE

NOTES:

1. ALL DIMENSIONS ARE IN MILLIMETERS UNLESS OTHERWISE INDICATED.

MINIMUM COMPRESSIVE STRENGTH OF CONCRETE SHALL BE 20.70 MPG FOR DRAINAGE APPURTENANT STRUCTURES.
ALL REINFORCING STEEL BARS SHALL CONFORM TO THE LATEST REQUIREMENTS OF PHILIPPINE NATIONAL STANDARD FOR DS8

WORK THIS DRAWING WITH SITE DEVELOPMENT AND DRAINAGE

#### LEGEND:

- ORDINARY BACKFILL MATERIAL HAND OR MACHINE TAMPED IN EVERY 150 mm LAYER.
- SELECTED BACKFILL MATERIAL WITH NO BOULDERS, VEGETABLE MATTERS & ETC., AND TAMPED IN EVERY 100 mm LAYER.
- SELECTED FILL OR ANY SUITABLE MATERIAL WITH NO BOULDERS, VEGETABLE MATTERS & ETC., AND TAMPED IN EVERY 150 mm LAYER.
- SAND OR NATURAL SANDY SOIL (BEDDING MATERIALS) ACCURATELY SHAPED TO FIT PIPE & HAND TAMPED IN EVERY 100 mm LAYER.
- (5) 13.7 MPa (2000 PSI) CONCRETE CRADLE.



# NATIONAL POWER CORPORATION GABRIEL Y. TICHON BLDG., SEN. MIRIAM P. DÉFENSOR-SANTIAGO AVENUE (FORMERLY BIR ROAD) CORNER QUEZON AVENUE, DILIMAN 1100 QUEZON CITY, PHILIPPINES

PROJECT: SUPPLY, DELIVERY, CONSTRUCTION, INSTALLATION, TESTING AND COMMISSIONING OF 10 MVA MASBATE (MALINTA) SUBSTATION

LOCATION: MALINTA, MASBATE

MLE:

DRAINAGE APPURTENANCES (CB-DS, TRENCHING, CATCH BASIN FOR PVC PIPES)

CHKD DATE H. L. NENDOZA Surmitted: DESIGNED Principol Engineer A, CEA
A. C. ESPIRITU DRAWN reviewed PRINCIPAL ENG'R. / ARCH'T. RECOMMENDED: CMIL/ARCH'T ELEC. APPROVED: <u>G. B. MAGPOC, JR</u> Manager, DDD

OWG. NO. MSS-BDC-22,021


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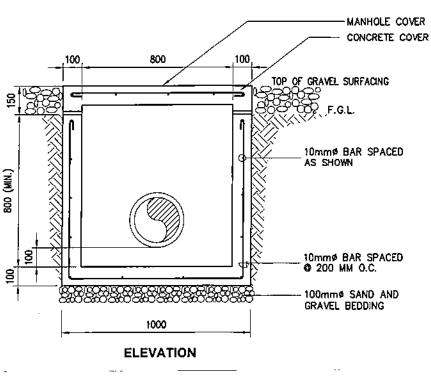
REV. O

BY CHKO, RECD. APPO. NATURE OF REVISION

REV. DATE SCALE: AS SHOWN

**BID DRAWING** 




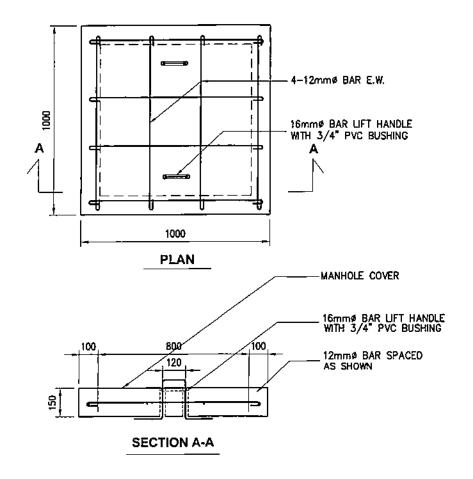


MANHOLE


1:20

SCALE

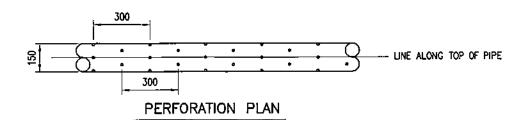

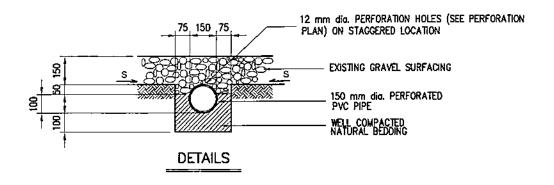

#### PERFORATED PVC PIPES SCALE 1:20

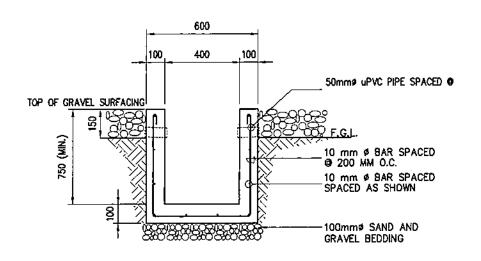

#### **ELEVATION**

### NOTES:

- 1. ALL DIMENSIONS ARE IN MILLUMETERS UNLESS OTHERWISE INDICATED.
- 2. MINIMUM COMPRESSIVE STRENGTH OF CONCRETE SHALL BE 20.70 MPa FOR DRAINAGE APPURTENANT STRUCTURES.
- ALL REINFORCING STEEL BARS SHALL CONFORM TO THE LATEST REQUIREMENTS OF PHILIPPINE NATIONAL STANDARD FOR DSB
- 4. WORK THIS DRAWING WITH SITE DEVELOPMENT AND DRAINAGE



# NATIONAL POWER CORPORATION GABRIEL Y, ITCHON BLDG., SEN, MIRIAM P, DEFENSOR-SANTIAGO AVENUE (FORMERLY BIR ROAD) CORNER QUEZON AVENUE, DILLIMAN 1100 QUEZON CITY, PHILIPPINES

PROJECT: SUPPLY, DELIVERY, CONSTRUCTION, INSTALLATION, TESTING AND COMMISSIONING OF 10 MVA MASBATE (MALINTA) SUBSTATION

LOCATION: MALINTA, MASBATE

**DRAINAGE APPURTENANCES** (MANHOLE, PERF. PVC PIPES, OPEN CONCRETE CANAL)

•	•			
	BY	CHK0	DATE_	Le H L RENDOZA
DESIGNED				SUBMITTED: H. L. MENDOZA Principal Engineer A, CEAD
DRAWN				-trem
REVIEWED	PRINCIPA	L ENG'R. /	ARCH'T.	RECOMMENDED: A. C. ESPIRITU
CML/ARCH'T				Manager, CEAD
ELEC.				APPROVED: G. B. MAGPOC, JR.
WECH.				Manager, DDD

DWG. NO. MSS-BDC-22.022

SPECS. NO.LuzP23Z1636Sce

SCALE: AS SHOWN

BY CHKD. RECO. APPO.


**BID DRAWING** 

REV. 0

OPEN CONCRETE CANAL SCALE 1:20

NATURE OF REVISION

REV. DATE

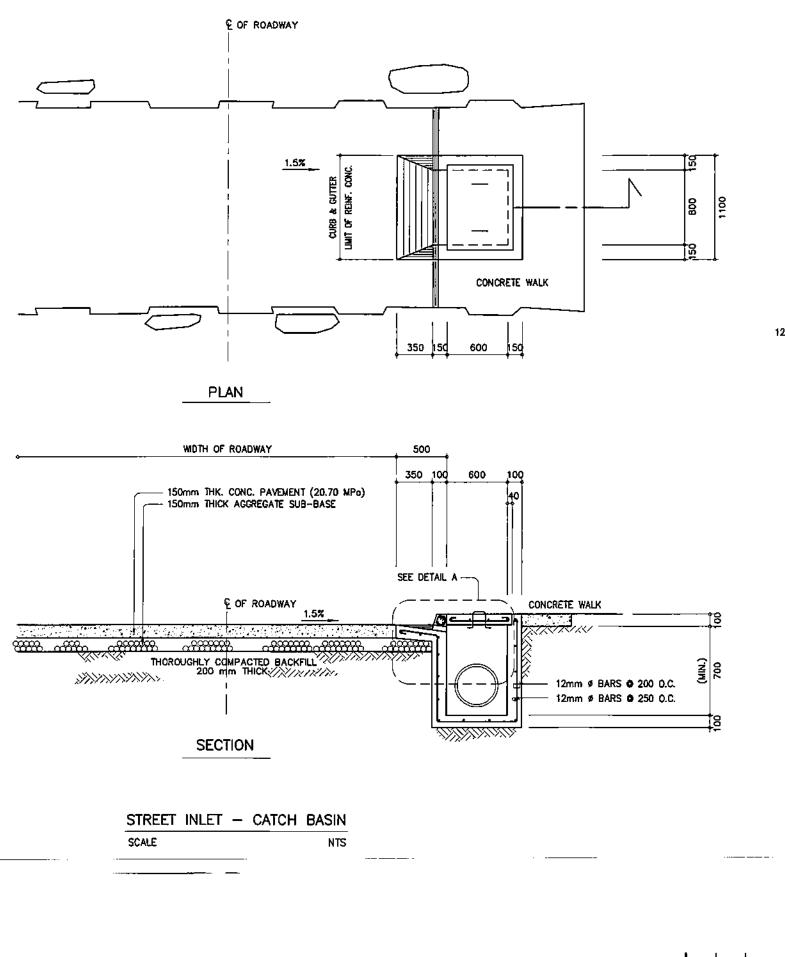


#### NOTES:

- 1. ALL DIMENSIONS ARE IN MILLIMETERS UNLESS OTHERWISE
- INDICATED.

  2. MINIMUM COMPRESSIVE STRENGTH OF CONCRETE SHALL BE 20.70 MPG FOR DRAINAGE APPURTENANT STRUCTURES.

  3. ALL REINFORCING STEEL BARS SHALL CONFORM TO THE LATEST REQUIREMENTS OF PHILIPPINE NATIONAL STANDARD FOR DSB GRADE 275.
- 4. THE CONTRACTOR SHALL VERIFY THE ACTUAL INVERT ELEVATIONS OF PIPES TO PREVENT BACKFLOW.
- 5. WORK THIS DRAWING WITH SITE DEVELOPMENT AND DRAINAGE

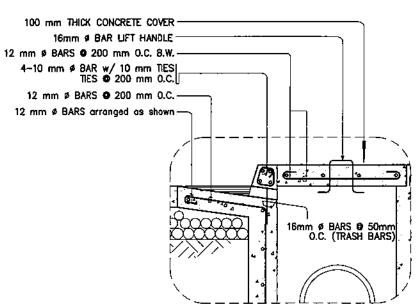

DETAIL A



NATIONAL POWER CORPORATION
GABRIEL Y, ITCHON BLDG., SEN, MIRIAM P, DEFENSOR-SANTIAGO
AVENUE (FORMERLY BIR ROAD) CORNER QUEZON AVENUE,
DILIMAN 1100 QUEZON CITY, PHILIPPINES

PROJECT: SUPPLY, DELIVERY, CONSTRUCTION, INSTALLATION, TESTING AND COMMISSIONING OF 10 MVA MASBATE (MALINTA) SUBSTATION

LOCATION: MALINTA, MASBATE

TITLE:

#### **DRAINAGE APPURTENANCES** (STREET INLET-CATCH BASIN)

		•		
	BY	CHKO	DATE	(m 117)
DESIGNED	T- '			SUBMITTED H. V. MENDOZA
DRAWN				Principal Engineer A, CEA
REVIEWED	PRINCIPA	L ENG'R. /	ARCH'T.	RECOMMENDED: A. C. ESPIRITU
CML/ARCHT				Manager, CEAD
ELEC.				APPROVED: G. B. MAGPOC, JR.
MECH.				Manager, DOD

DWG. NO. MSS-BDC-22.023

SPECS. NO.LuzP23Z1636Sce


REV. 0


BY CHKO, RECO. APPO. SCALE: AS SHOWN

REV. DATE

NATURE OF REVISION

**BID DRAWING** 

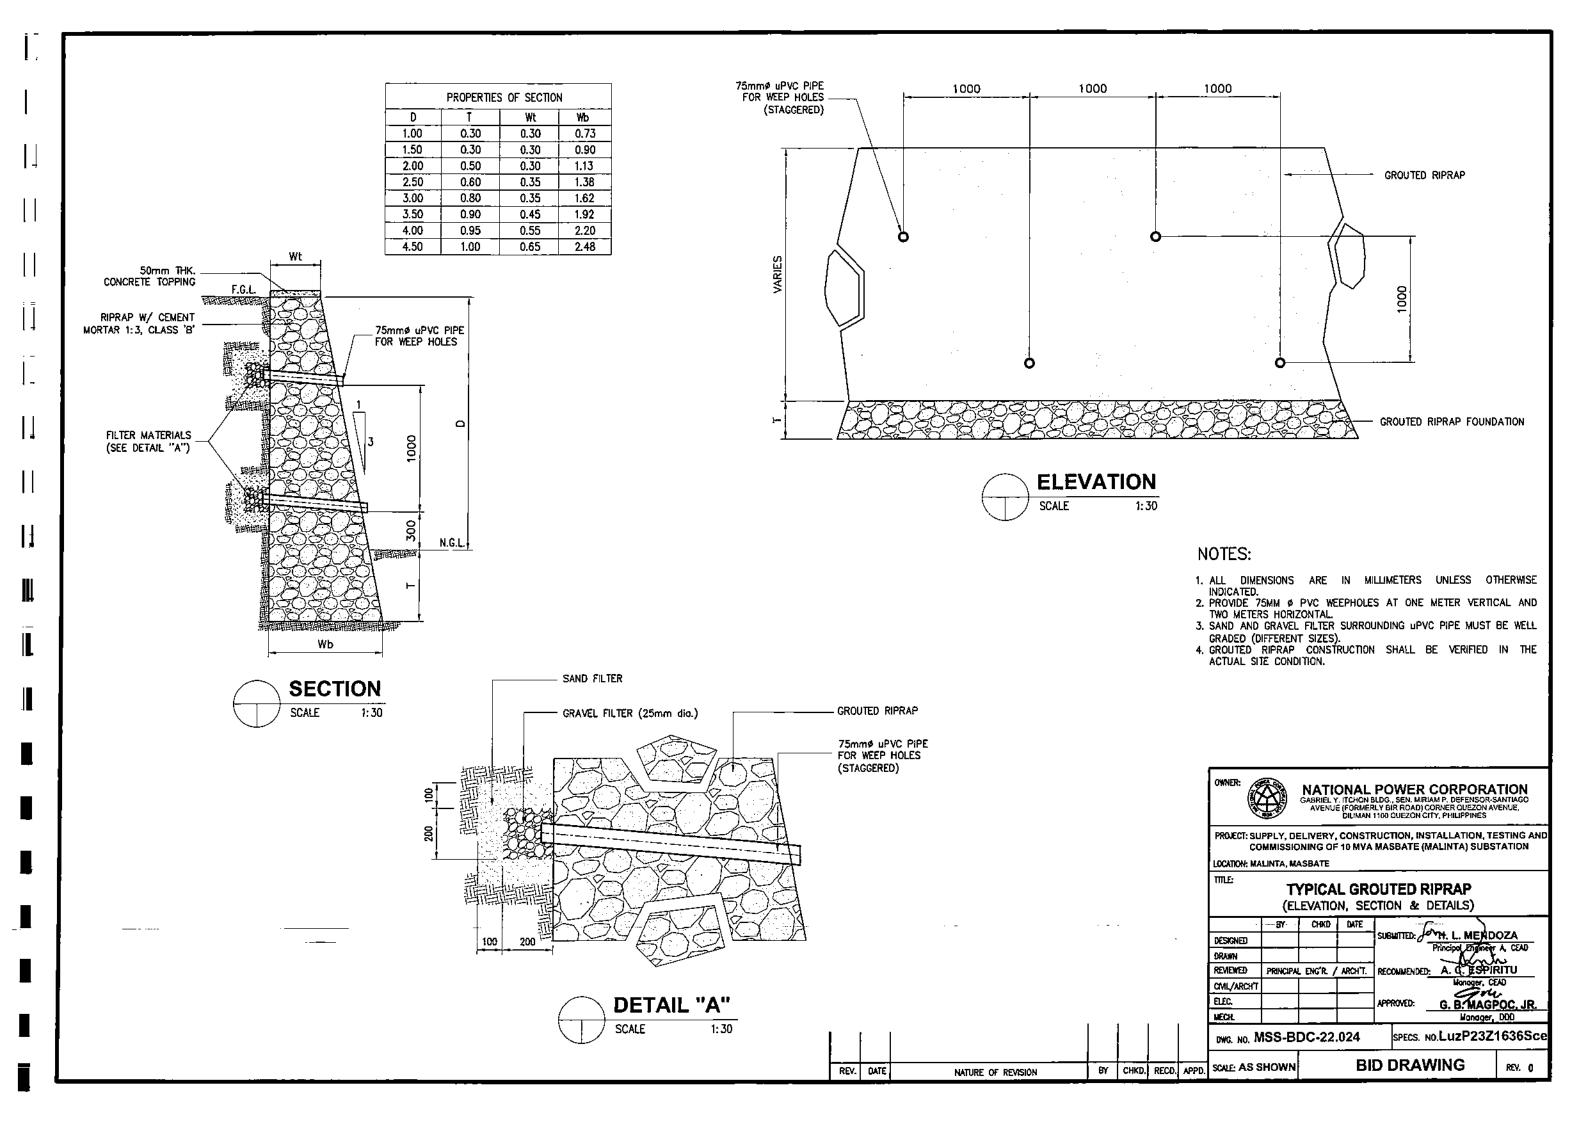

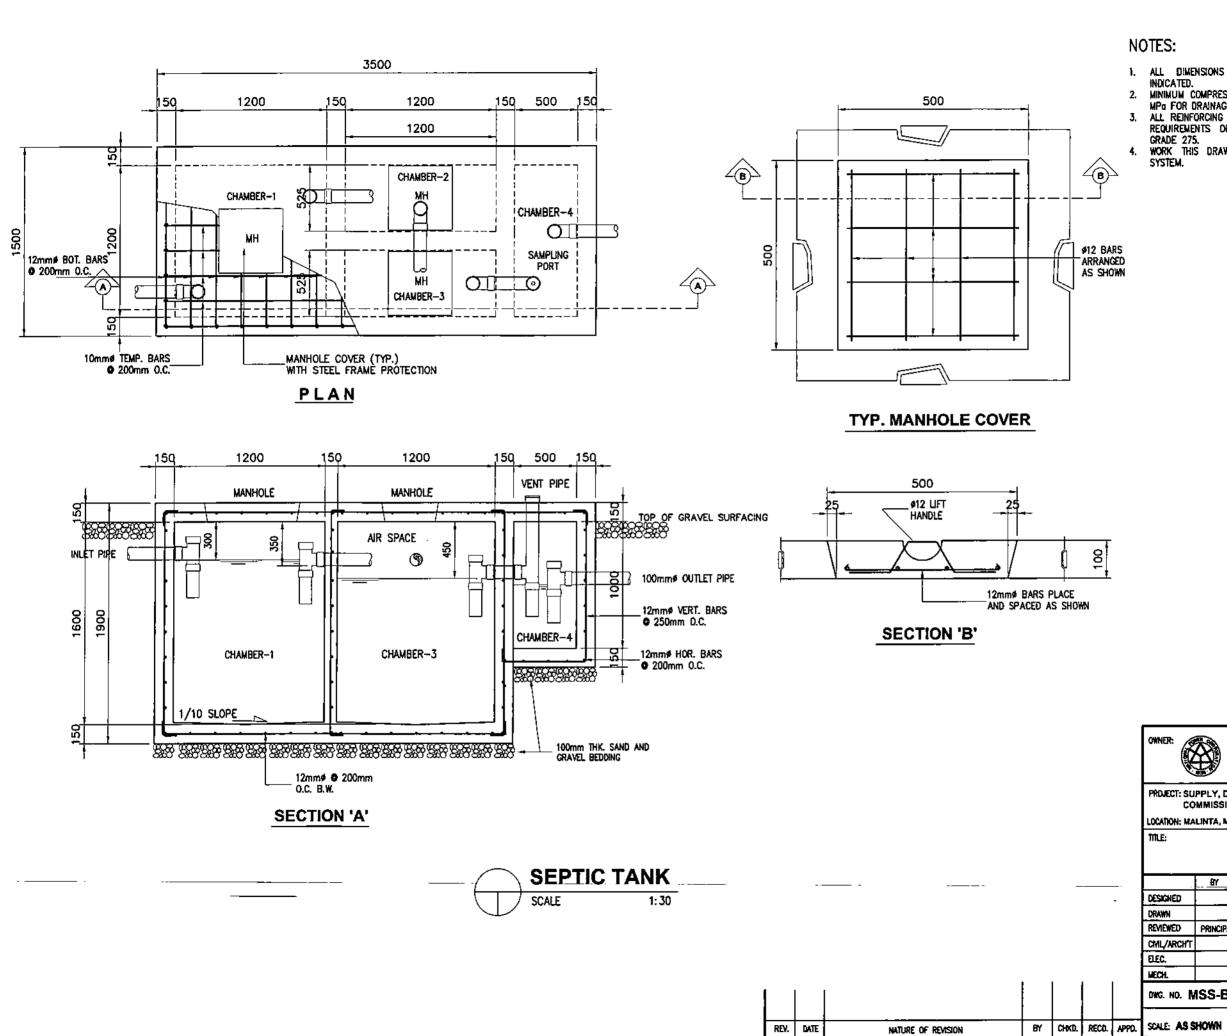

- 1. ALL DIMENSIONS ARE IN MILLIMETERS UNLESS OTHERWISE
- MINIMUM COMPRESSIVE STRENGTH OF CONCRETE SHALL BE 20.70 MPg FOR DRAINAGE APPURTENANT STRUCTURES.
- ALL REINFORCING STEEL BARS SHALL CONFORM TO THE LATEST REQUIREMENTS OF PHILIPPINE NATIONAL STANDARD FOR DSB GRADE 275.
- 4. WORK THIS DRAWING WITH SITE DEVELOPMENT AND DRAINAGE

NATIONAL POWER CORPORATION GABRIEL Y, ITCHON BLDG., SEN, MIRIAM P. DEFENSOR-SANTIAG AVENUE (FORMERLY BIR ROAD) CORNER QUEZON AVENUE, DILIMAN 1100 QUEZON CITY, PHILIPPINES PROJECT: SUPPLY, DELIVERY, CONSTRUCTION, INSTALLATION, TESTING AND COMMISSIONING OF 10 MVA MASBATE (MALINTA) SUBSTATION LOCATION: MALINTA, MASBATE TYPICAL SEPTIC TANK (PLAN, SECTION & DETAILS) CHKO DATE SUBMITTED: A. H. L. MENDOZA A.C. ESPIRITU PRINCIPAL ENG'R. / ARCH'T. RECOMMENDED: Honoger, CEAD G. B. MAGPOC, JR. Manager, 000 SPECS. NO.LUZP23Z1636SCE DWG. NO. MSS-BDC-22.025 **BID DRAWING** REV. 0

### **SECTION IX - BID DRAWINGS**

### **EW - ELECTRICAL DRAWINGS**


DRAWING NO.	TITLE
MSS-BDE-22.001	SINGLE LINE DIAGRAM
MSS-BDE-22.002	230VAC LOW VOLTAGE PANEL (MAIN DISTRIBUTION BOARD)
MSS-BDE-22.003	230VAC LOW VOLTAGE PANEL (SUB-DISTRIBUTION BOARD)
MSS-BDE-22.004	125VDC SYSTEM REQUIREMENTS
MSS-BDE-22.005	EQUIPMENT LAYOUT
MSS-BDE-22.006	SECTIONAL VIEW
MSS-BDE-22.007	CONTROL HOUSE PANEL LAYOUT
MSS-BDE-22.008	CONTROL HOUSE TRENCH/TRAY/CONDUIT LAYOUT
MSS-BDE-22.009	CABLE TRENCH & TRAY LAYOUT
MSS-BDE-22,010	SWITCHYARD CONDUIT LAYOUT
MSS-BDE-22.011	GROUNDING SYSTEM LAYOUT
MSS-BDE-22.012	CONTROL HOUSE LIGHTING LAYOUT
MSS-BDE-22.013	CONTROL HOUSE POWER LAYOUT
MSS-BDE-22.014	PERIMETER LIGHTING LAYOUT
MSS-BDE-22.015	GUARDHOUSE ENTRANCE GATE AND PUMPHOUSE LIGHTING & POWER LAYOUT
MSS-BDE-22.016	SCHEDULE OF LOADS AND RISER DIAGRAM OF LPP
MSS-BDE-22.017	LIGHTING FIXTURE DETAILS
MSS-BDE-22.018	PERIMETER LIGHTING CONTROLLER
MSS-BDE-22.019	TELEPHONE SYSTEM LAYOUT
MSS-BDE-22.020	VOICE AND DATA SYSTEM RISER DIAGRAM
MSS-BDE-22.021	CCTV SURVEILLANCE SYSTEM


SECTION IX - BID DRAWINGS

LuzP23Z1636Sce

MSS-BDE-22.022 VIDEO SURVEILLANCE SYSTEM RISER DIAGRAM

MSS-BDE-22.023 MASBATE SUBSTATION NETWORK ARCHITECTURE

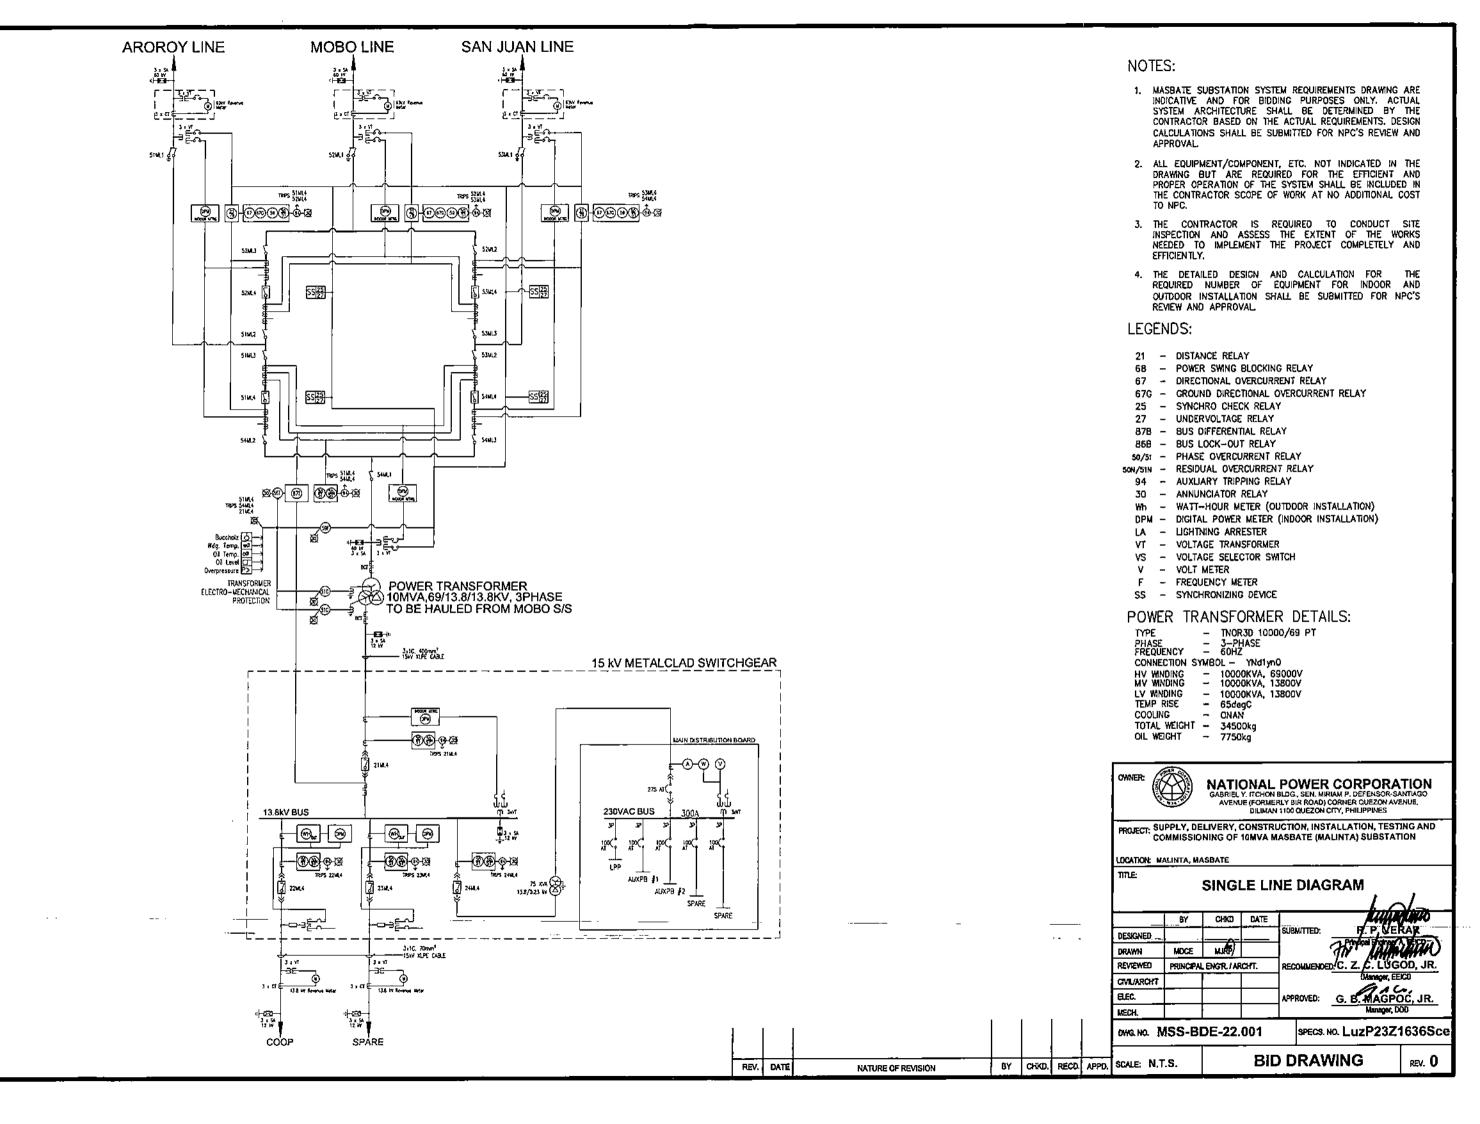

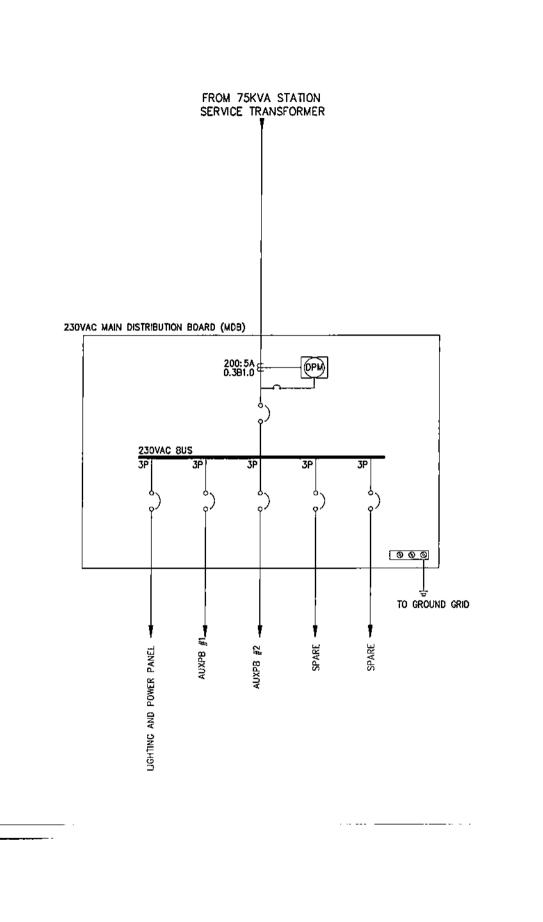

NATURE OF REVISION

### NOTES:

- 1. THE NUMBERS OF BUS, FEEDERS AND CIRCUIT BREAKERS RATINGS ARE TENTATIVE AND FOR BIDDING PURPOSES ONLY. THE ACTUAL NUMBER OF FEEDERS AND CIRCUIT BREAKER SHALL BE DETERMINED BY THE CONTRACTOR. DETAILED DESIGN CALCULATION SHALL BE SUBMITTED FOR NPC'S REVIEW AND APPROVAL
- 2. THE CONTRACTOR SHALL SECURED ALL THE NECESSARY DOCUMENTS FOR THE CONNECTION OF POWER SUPPLY FROM THE AVAILABLE LOCAL COOPERATIVE FOR SWITCHING STATION

### LEGENDS:

DPM - DIGITAL POWER METER (INDOOR INSTALLATION)

LA - LIGHTNING ARRESTER



NATIONAL POWER CORPORATION
GABRIEL Y, ITCHON BLOG, SEN, MIRIAM P. DEFENSOR-SANTIAGO
AVENUE (FORMERLY BIR ROAD) CORNER CUEZON AVENUE,
DILIMAN 1100 QUEZON CITY, PHILIPPRIES

PROJECT: SUPPLY, DELIVERY, CONSTRUCTION, INSTALLATION, TESTING AND COMMISSIONING OF 10MVA MASBATE (MALINTA) SUBSTATION

LOCATION: MALINTA, MASBATE

230 VAC LOW VOLTAGE PANEL (MAIN DISTRIBUTION BOARD)


	BY	CHKO	DATE	Marina
DESIGNED	4			SUBMITTED: F. P. VERAR
DRAWN	60 Po_	MOCE		
REVTEWED	PRINCIPAL ENGR. / ARCHT.			RECOMMENDED: C. Z. C/LUGOD, JR.
CIVILIARCHT				Winger, EEICO
B.EC.				APPROVED: G. BMAGPOC, JR.
MECH.				Manager, COD

DWG.NO. MSS-BDE-22.002

SPECS. NO. LuzP23Z1636Sce

**BID DRAWING** BY CHKD. RECD. APPO. SCALE: N.T.S.

REV. O

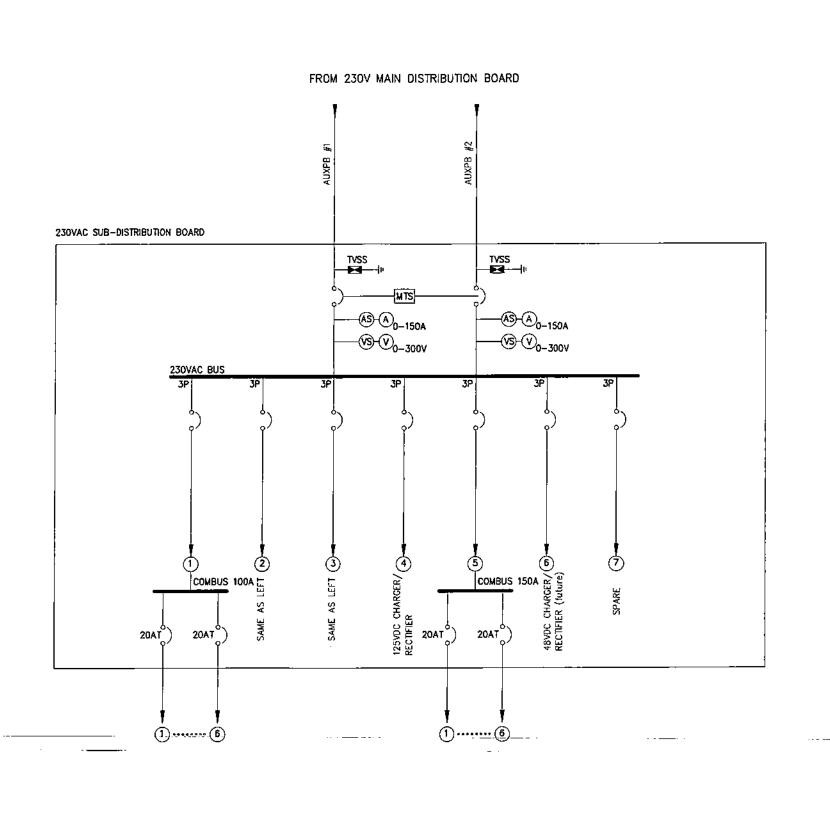

1.

# NOTES:

- THE NUMBERS OF BUS, FEEDERS AND CIRCUIT BREAKERS RATINGS ARE TENTATIVE AND FOR BIDDING PURPOSES ONLY. THE ACTUAL NUMBER OF FEEDERS AND CIRCUIT BREAKER SHALL BE DETERMINED BY THE CONTRACTOR. DETAILED DESIGN CALCULATION SHALL BE SUBMITTED FOR NPC'S REVIEW AND APPROVAL
- ALL DEVICES SUCH AS METERS, INSTRUMENT TRANSFORMERS AND OTHER APPURTENANCES ALTHOUGH NOT INDICATED IN THE DRAWING SHALL BE SUPPLIED BY THE CONTRACTOR. TO FULFILL THE REQUIREMENT FOR MANUAL TRANSFER SWITCH AND INTERLOCKING FUNCTION. ALL INTERLOCK DEVICES SHALL ALSO BE PROVIDED

# LEGENDS:

MTS - MANUAL TRANSFER SWITCH

TVSS - TRANSIENT VOLTAGE SURGE SUPPRESSOR

A - AMMETER

V - VOLTMETER

As - AMMETER SWITCH

Vs - VOLTMETER SWITCH



NATIONAL POWER CORPORATION
GABRIELY, ITCHON BLDG, SEN. MIRIAM P. DEFENSOR-SANTAGO
AVENUE (FORMERLY BIR ROAD) CORNER QUEZON AVENUE,
DILIMAN 1100 QUEZON CITY, PHILIPPINES

PROJECT: SUPPLY, DELIVERY, CONSTRUCTION, INSTALLATION, TESTING AND COMMISSIONING OF 10MVA MASBATE (MALINTA) SUBSTATION

LOCATION: MALINTA, MASBATE

230 VAC LOW VOLTAGE PANEL (SUB-DISTRIBUTION BOARD)

	BY	CHKO	DATÉ	
DESIGNED	<u> </u>	-		Submitted:
DRAWN	Me	MDCE		]
REVIEWED	PRINCIPAL	ENGR. / AR	CHT.	RECOMMENDE
CIVILIARCHT				Ì
BEC	ľ			LOODOLED.

DWG. NO. MSS-BDE-22.003

WECH


NATURE OF REVISION

specs. No. LuzP23Z1636Sce

G. B.MAGPOC, JR.

**BID DRAWING** BY CHIKD. RECD. APPD. SCALE: N.T.S.

rev. O

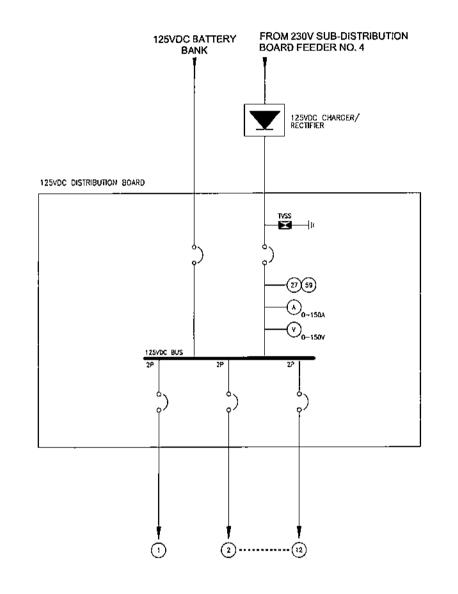

NATURE OF REVISION

# NOTES:

1. THE NUMBERS OF BUS, FEEDERS AND CIRCUIT BREAKERS RATINGS ARE TENTATIVE AND FOR BIDDING PURPOSES ONLY. THE ACTUAL NUMBER OF FEEDERS AND CIRCUIT BREAKER SHALL BE DETERMINED BY THE CONTRACTOR. DETAILED DESIGN CALCULATION SHALL BE SUBMITTED FOR NPC'S REVIEW AND APPROVAL

# LEGENDS:

TVSS - TRANSIENT VOLTAGE SURGE SUPPRESSOR

(A) - AMMETER

(V) - VOLTMETER

27 - UNDERVOLTAGE RELAY

(59) - OVERVOLTAGE RELAY



NATIONAL POWER CORPORATION
GABRIEL, Y. ITCHON BLDG., SEN. MIRIAM P. DEFENSOR-SANTIAGO
AVENUE (FORMERLY BIR ROAD) CORNER QUEZON AVENUE,
DILIMAN 1100 QUEZON CITY, PHILIPPINES

PROJECT: SUPPLY, DELIVERY, CONSTRUCTION, INSTALLATION, TESTING AND COMMISSIONING OF 10MVA MASBATE (MALINTA) SUBSTATION

LOCATION: MALINTA, MASBATE

BY CHIKO, RECO. APPO.

125VDC SYSTEM REQUIREMENTS

				_	· 0/2
	BY	CHKD	DATE		R. P. VERAR
DESIGNED	4			SUBMITTED:	<del></del>
DRAWN	(Ciple)	MDCE			Tirdical Endroon A EEE THUR
REVIEWED	PRINCIPA	LENGTE / AF	CHT.	RECOMMENDE	
CIVIL/ARCHT					Mapager, EEICD
ELEC.				APPROVED:	G. B. MAGPOC, JR.
MECH.					Manager, DOD


DWG. NO. MSS-BDE-22.004

SPECS. NO. LuzP23Z1636Sce

SCALE: N.T.S.

**BID DRAWING** 

rev. O

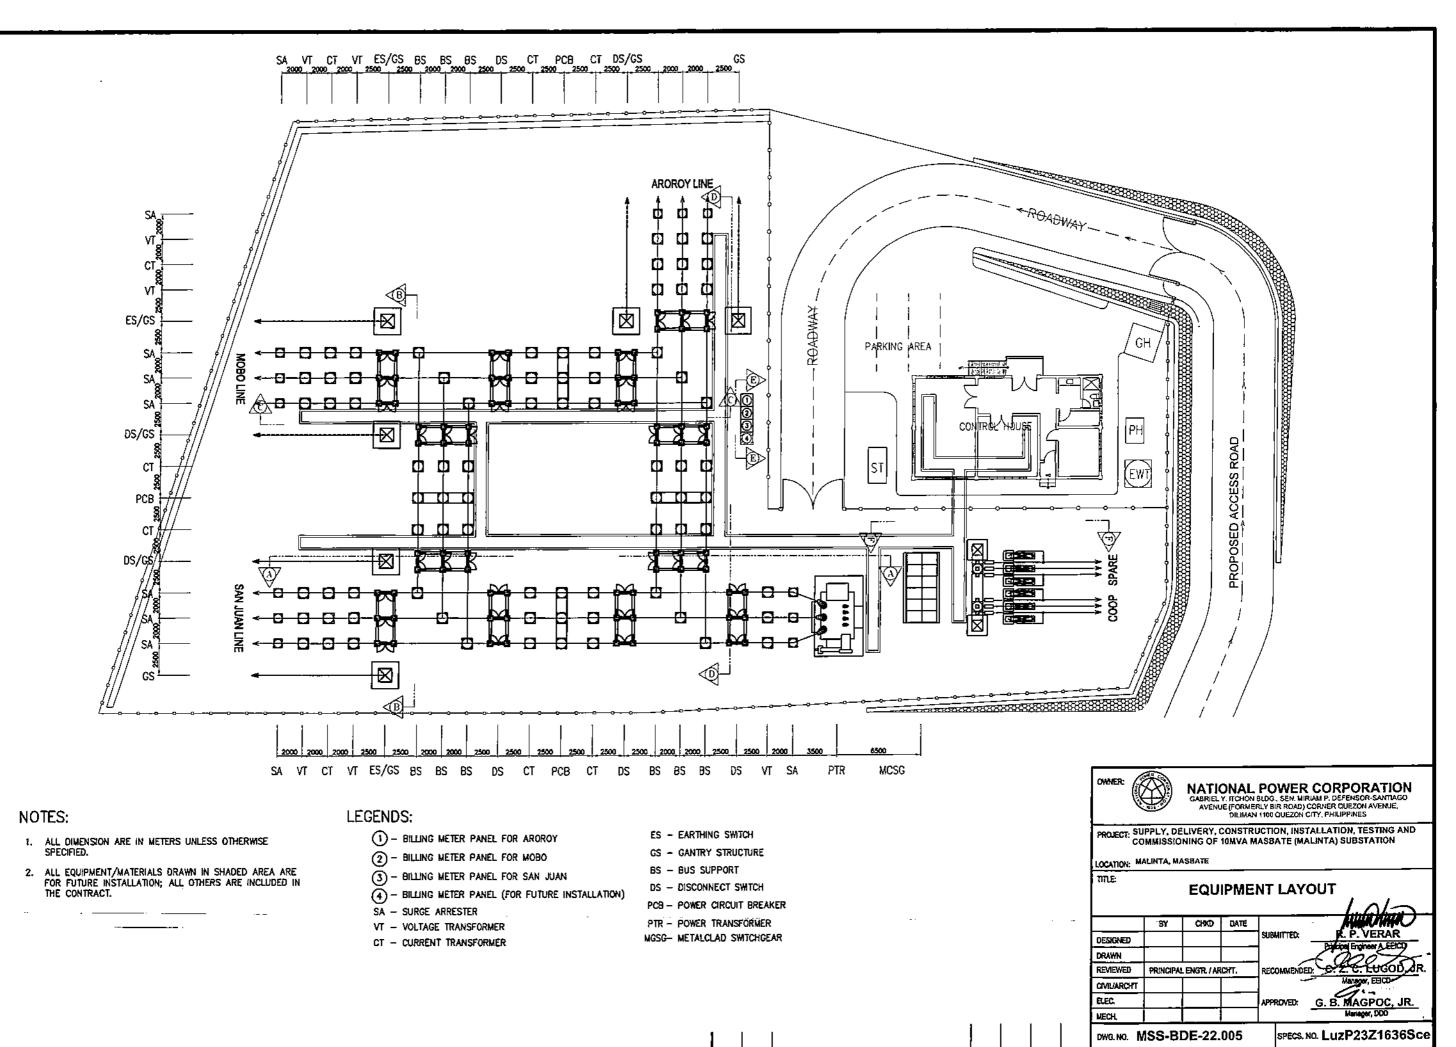



NATURE OF REVISION

**BID DRAWING** 

SCALE: 1:300

BY CHKD. RECO. APPD.

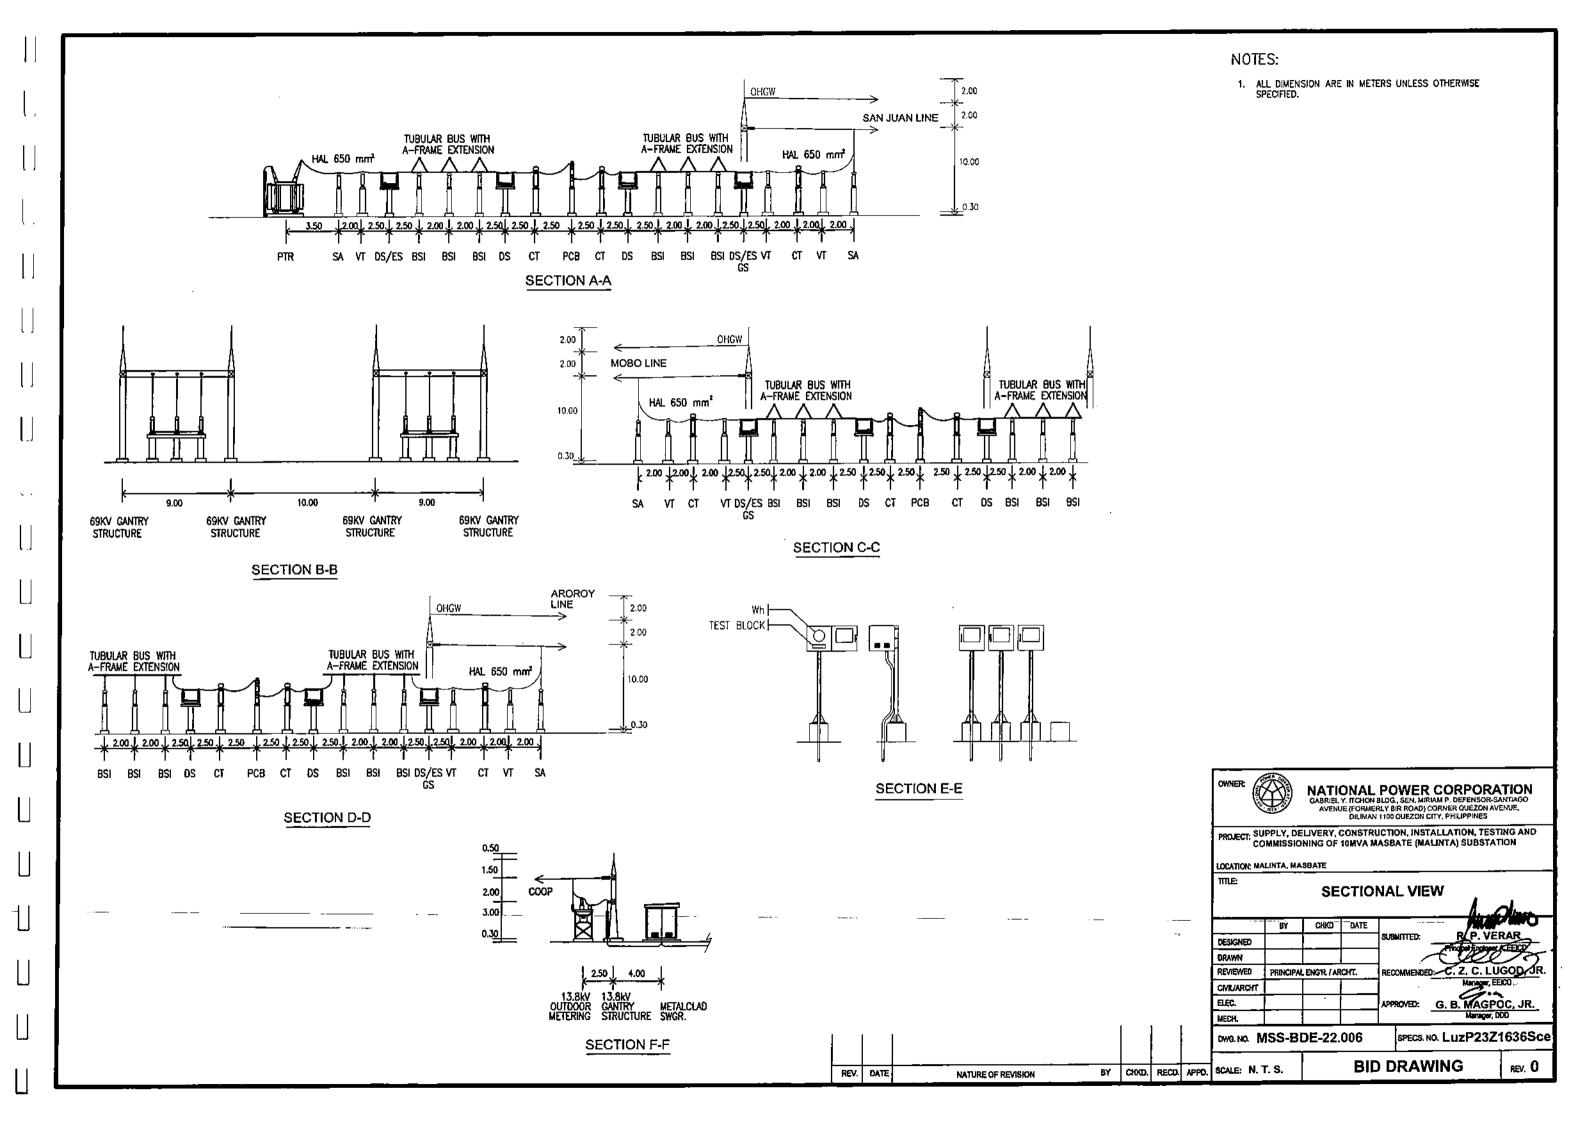

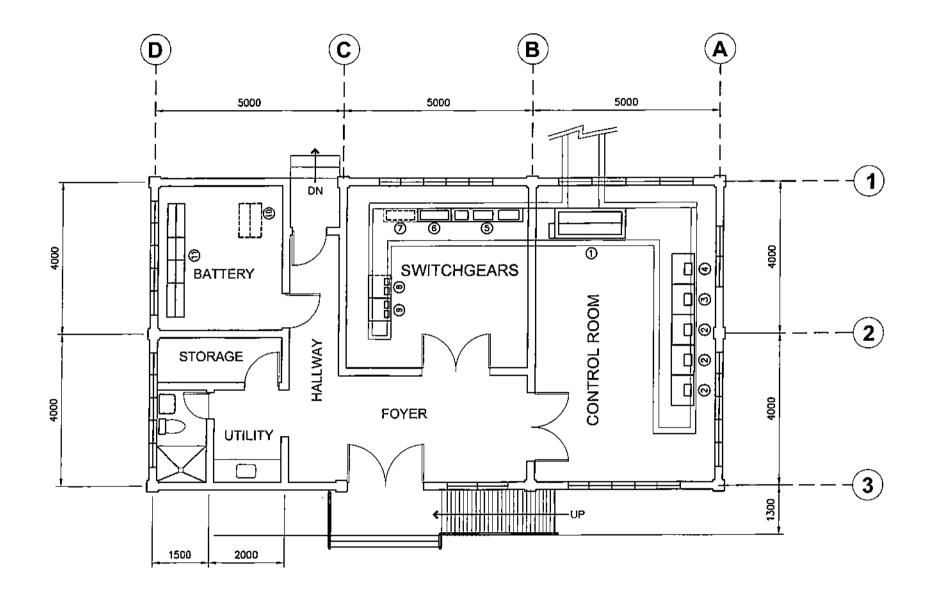

NATURE OF REVISION

# NOTES:

- 1. ALL DIMENSIONS ARE IN METERS UNLESS OTHERWISE SPECIFIED.
- SIZES AND LOCATION OF PANELS ARE INDICATIVE ONLY, ACTUAL LOCATION SHALL BE DETERMINED BY THE CONTRACTOR FOR NPC APPROVAL.

# LEGENDS:

- 1 MAIN CONTROL SWITCHBOARD (69kV)
- 2 LINE PROT'N. PANEL
- 3) TRANSFORMER PROT'N, PANEL
- F) TRANSFORMER OLTC PANEL
- 230 Vac LOW VOLTAGE(MAIN DISTRIBUTION BOARD AND SUB-DISTRIBUTION BOARD)
- ) 125 Vdc AUXILIARY PANEL
- 7 48 Vdc AUXILIARY PANEL (FUTURE)
- ) 48 Vdc RECTIFIER/CHARGER (FUTURE)
- 9 125 Vdc RECTIFIER/CHARGER
- 48 Vdc STORAGE BATTERIES (FUTURE)
- 7) 125 Vdc STORAGE BATTERIES



# NATIONAL POWER CORPORATION

GABRIEL Y, ITCHON BLOG., SEN. MIRIAM P, DEFENSOR-SANTIAGO AVENUE (FORMERLY BIR ROAD) CORNER QUEZON AVENUE, DILIMAN 1100 QUEZON CITY, PHILIPPINES

PROJECT: SUPPLY, DELIVERY, CONSTRUCTION, INSTALLATION, TESTING AND COMMISSIONING OF 10MVA MASBATE (MALINTA) SUBSTATION

LOCATION: MALINTA, MASBATE

TILE

# **CONTROL HOUSE PANEL LAYOUT**


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	BY	CHKD	DATE		
DESIGNED				SUBMITTED: PHODE TO A VERAB	2_
DRAWN				J ( King )	ク
REVIEWED	PRINCIPA	LENGR./AF	ICHT.	RECOMMENDED: C. Z. C. LUGOD, 1	Ŕ.
CIVILIARCHT				Manager, EEICO	
ELEC.		<u>.</u>		APPROVED: G. B. MAGPOC, JR.	_
MECHL				Manager, DOD	

DWG. NO. MSS-BDE-22,007

SPECS. NO. LuzP23Z1636Sce

BY CHKD. RECD. APPD. SCALE: 1:100

BID DRAWING

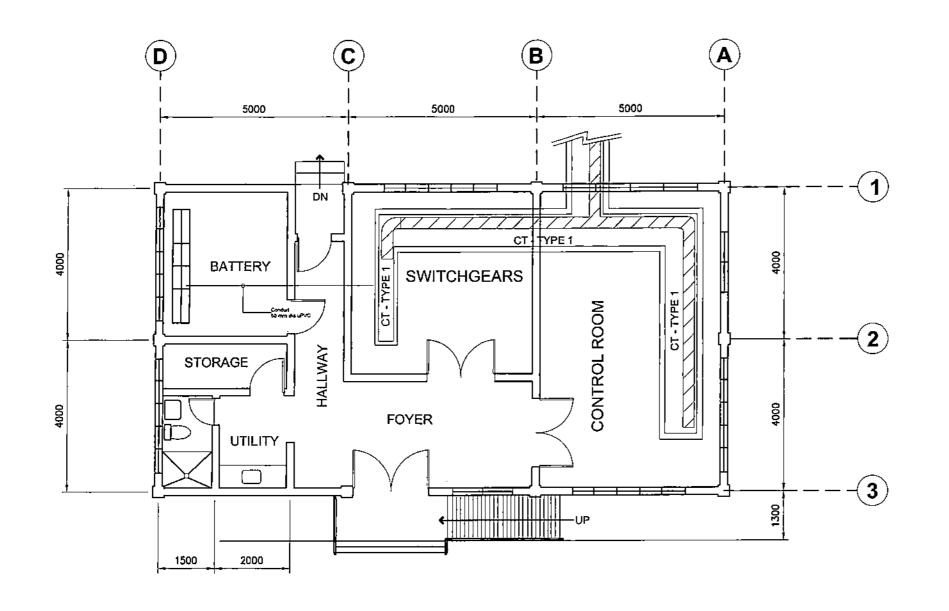

NATURE OF REVISION

# NOTES:

- ALL DIMENSIONS ARE IN MÉTERS UNLESS OTHERWISE SPECIFIED.
- 2. CABLE TRAY SHALL BE ST-300, ST-450 OR AS INDICATED.
- 3. CABLE TRAY SUPPORT SHALL BE SPACED 1.50 METERS
- THE CONDUIT SHALL BE uPVC CONDUIT, THICK WALL, SCH. 40 AND RED ORANGE IN COLOR.
- CONDUITS ARE SCHEMATIC, ACTUAL RUNS SHALL BE DETERMINED DURING INSTALLATIONS.
- THE CONTRACTOR SHALL SUBMIT DETAILED CONDUIT INSTALLATION PROCEDURE TO BE APPROVED BY NPC.

# LEGENDS:

- CABLE TRAY (STRAIGHT TYPE)

- CABLE TRAY (HORIZONTAL TEE TYPE)

- CABLE TRAY (90' HORIZONTAL ELBOW)

- CABLE TRAY (30" HORIZONTAL ELBOW)

- CONDUIT



# NATIONAL POWER CORPORATION GABRIEL Y, ITCHON BLDG, SEN, NIRVAM P, DEFENSOR-SANTIAGO AVERUE (FORMERLY BIR ROAD) CORNER QUEZON AVENUE, DILIMAN 1100 QUEZON CITY, PHILIPPIRES

PROJECT: SUPPLY, DELIVERY, CONSTRUCTION, INSTALLATION, TESTING AND COMMISSIONING OF 18MVA MASBATE (MALINTA) SUBSTATION

LOCATION: MALINTA, MASBATE

TITLE:

CONTROL HOUSE TRENCH/
TRAY/CONDUIT LAYOUT

,				
	BY	CHKD	DATE	MANUAL MACO
DESIGNED				SUBMITTED: R. P. VERAR
DRAWN				4 60073
REVIEWED	PRINCIPAL	LENGR. / AF	CHT.	RECOMMENDED: C. Z. C. LUGOD OR.
CIVILLARCHT	Γ			Manager, EEICD
B.EC.				APPROVED: G. B. MAGPOC, JR.
MECH				Manager, DOD


DWG.NO. MSS-BDE-22,008

SPECS, NO. LuzP23Z1636Sce

REV. O

BY CHKD. RECO. APPD. SCALE: 1:100

**BID DRAWING** 

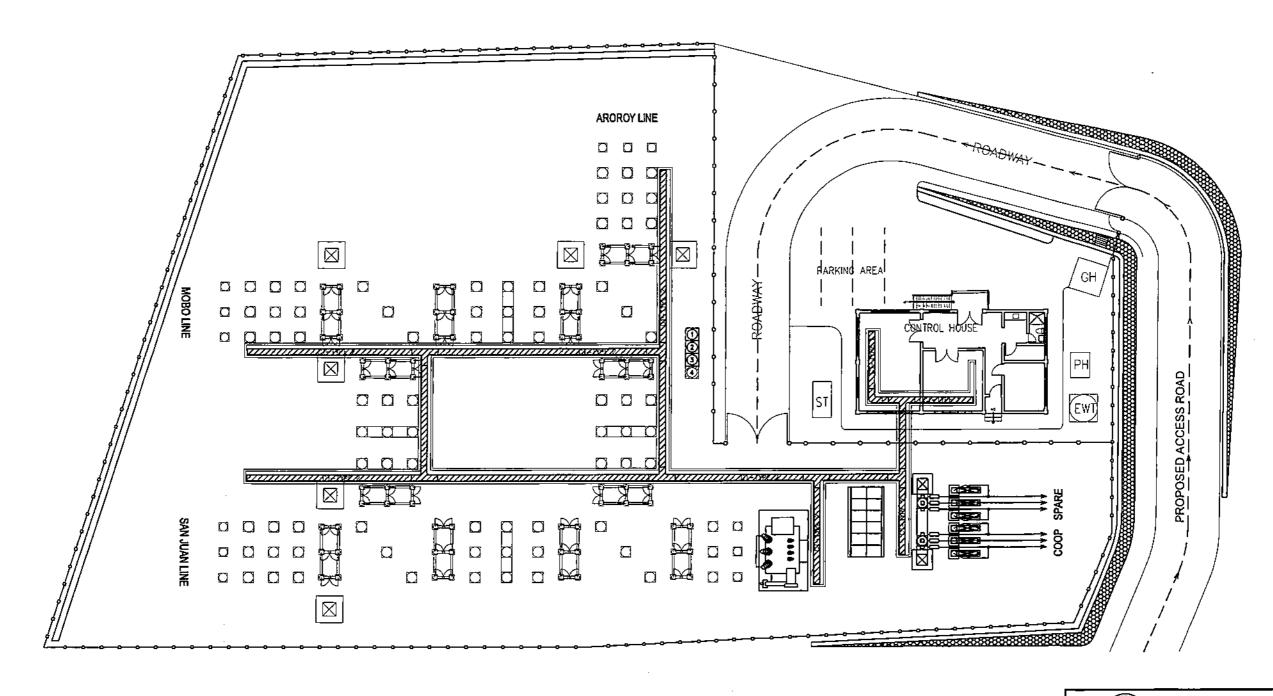

- ALL DIMENSIONS ARE IN METERS UNLESS OTHERWISE SPECIFIED.
- 2. ALL WORKS SHALL BE DONE IN ACCORDANCE WITH THE PROVISION OF THE LATEST EDITION OF THE PHILIPPINE ELECTRICAL CODE, THE EXISTING LOCAL ORDINANCE AND RULES AND REGULATIONS OF LOCAL AUTHORITY.
- 3.\_\_THE\_CABLE TRAY SHALL BE ST-300, ST-450 OR AS INDICATED.
- 4. CABLE TRAY SUPPORT SHALL BE SPACED 1.50 METERS APART.

### LEGENDS:

TOTAL - CABLE TRAY (STRAIGHT TYPE)

- CABLE TRAY (HORIZONTAL TEE TYPE)

- CABLE TRAY (90' HORIZONTAL ELBOW)

- CABLE TRAY (30' HORIZONTAL ELBOW)

REV. DATE



# NATIONAL POWER CORPORATION GABRIEL Y, ITCHON BLDG, SEN, MIRIAM P, DEFENSOR SANTAGO AVENUE (FORMERLY BIR ROAD) CORNER QUEZON AVENUE, DILIMAN 1100 QUEZON GITY, PHILIPPINES

PROJECT: SUPPLY, DELIVERY, CONSTRUCTION, INSTALLATION, TESTING AND COMMISSIONING OF 10 MVA MASBATE SUBSTATION PROJECT

LOCATION: MALINTA, MASBATE


### **CABLE TRENCH & TRAY LAYOUT**

l				-100
	BY -	CHAO	DATE	- Julyovan
DESIGNED				SUBMITTED: Product Englishmen A SECO 2
DRAWN				1000
REVIEWED	PRINCIPAL	ENGTR / AR	ICHT.	RECOMMENDED: C. Z. C. LUGOD, JR.
CIVILIARCHT				Manager, EEICO
ELEC.				APPROVED: G. B. MAGPOC, JR.
MÉCH				Manager, ODO

DWG.NO. MSS-BDE-22.009

SPECS. NO. LuzP23Z1636Sce

**BID DRAWING** BY CHKD. RECD. APPO. SCALE: 1:300 NATURE OF REVISION

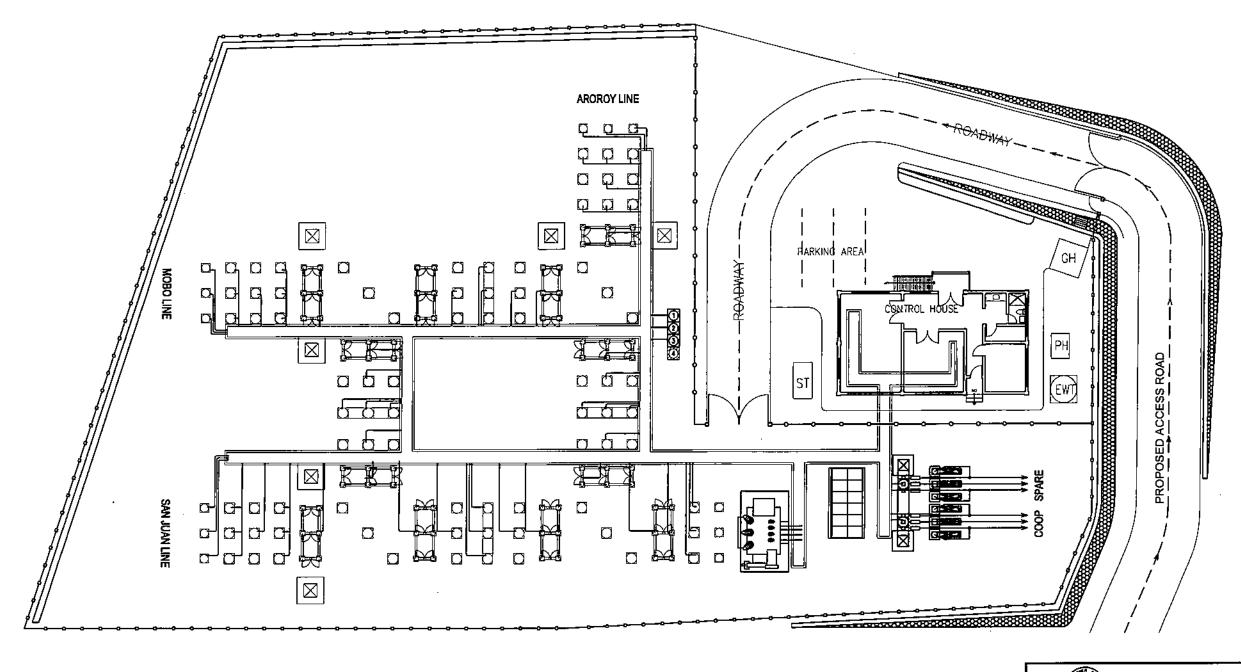

- 1. ALL DIMENSIONS ARE IN METERS UNLESS OTHERWISE SPECIFIED.
- 2. ALL WORKS SHALL BE DONE IN ACCORDANCE WITH THE PROVISION OF THE LATEST EDITION OF THE PHILIPPINE ELECTRICAL CODE, THE EXISTING LOCAL ORDINANCE AND RULES AND REGULATIONS OF LOCAL AUTHORITY.
- -3:-THE--CONDUITS SHALL BE-UPVC CONDUIT, THICK WALL;
   SCH\_40\_AND RED ORANGE IN COLOR.
- CONDUITS ARE SCHEMATIC, ACTUAL RUNS SHALL BE DETERMINED DURING INSTALLATIONS.
- 5. THE CONTRACTOR SHALL SUBMIT DETAILED CONDUIT INSTALLATION PROCEDURE TO BE APPROVED BY NPC.

### CONDUIT SCHEDULE:

1x90mm. ø uPVC 2x50mm. ø uPVC FOR SA: 3x20mm. Ø uPVC FOR DS: 2x50mm. ø uPV0 FOR CT: . 2x50mm, ø\_uPVC FOR VT: 2x50mm. ø uPVC FOR BMP: 2x50mm. ø uPVC FOR CSE: 2x120mm, Ø uPVC

# LEGENDS:

REV. DATÉ

– CONDUIT

NATURE OF REVISION

2x25mm. ø uPVC

NATIONAL POWER CORPORATION
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AVENUE (FORMERLY BIR ROAD) CORNER QUEZON AVENUE,
DILIMAN 1100 QUEZON CITY, PHILIPPINES

PROJECT: SUPPLY, DELIVERY, CONSTRUCTION, INSTALLATION, TESTING AND COMMISSIONING OF 10MVA MASBATE (MALINTA) SUBSTATION

LOCATION: MALINTA, MASBATE

TIRLE:

# SWITCHYARD CONDUIT LAYOUT


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	SY	- CHKD-	DATE		
DESIGNED		1		] SUBMITTED:	Pr. P. VERAR
DRAWN				] ~{	90075
REVIEWED	PRINCIPA	L ENGR. / AF	RCHT.	RECOMMENDED:	C. Z. C. LUGQD, JR.
CIVILIARCHT					Manager, EEICO
ELEC.	<u> </u>		<u> </u>	APPROVED: G.	B.MAGPOC, JR.
MECH	_	<u> </u>			Manager, ODO

DWG. NO. MSS-BDE-22.010

SPECS. NO. LuzP23Z1636Sce

BY CHKD. RECD. APPD. SCALE: 1:300

**BID DRAWING** 

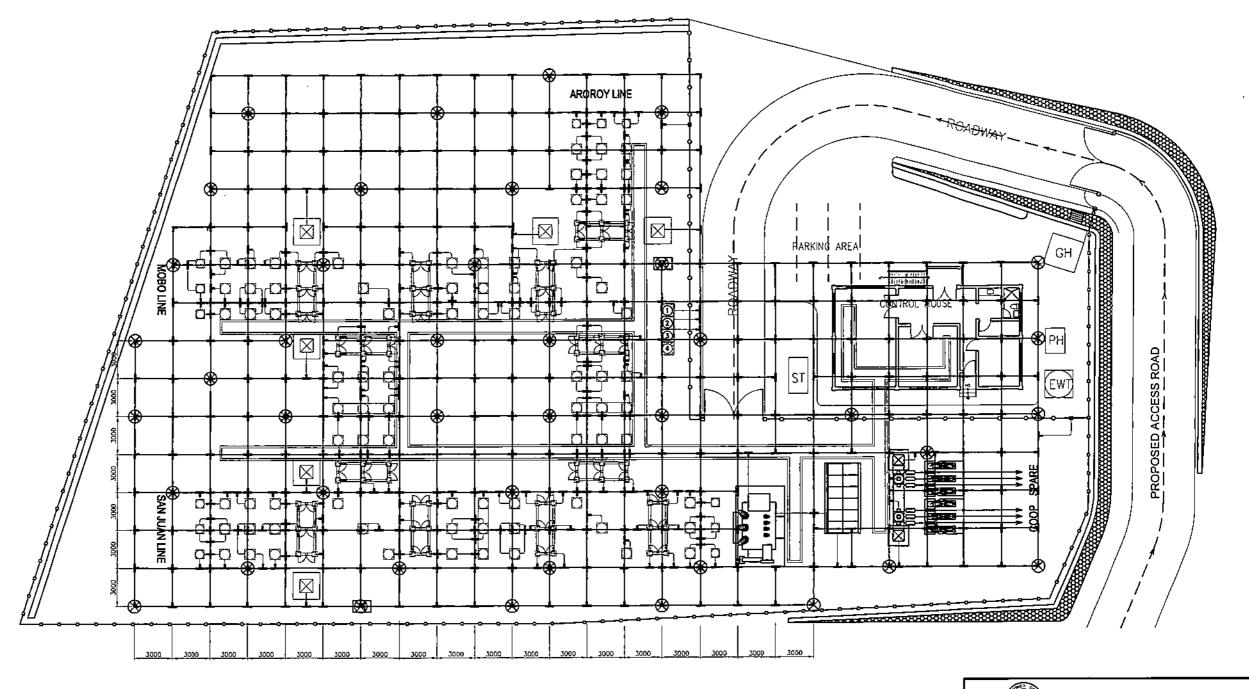

NATURE OF REVISION

# NOTES:

- 1. ALL DIMENSIONS ARE IN METERS UNLESS OTHERWISE SPECIFIED.
- 2. GROUNDING MAT SHALL BE BURIED TO O.6M DEPTH.
- 3. ALL MAJOR ELECTRICAL EQUIPMENT SHALL BE CONNECTED TO THE GROUNDING MAT BY 2X100 SQ.MM. PVC INSULATED COPPER CONDUCTOR.
- SECLUSION FENCE.INCLUDING THE PERIMETER LIGHTING POLES SHALL BE CONNECTED TO THE GROUNDING MAT.
- 5. EQUIPMENT INSIDE THE CONTROL HOUSE SHALL BE PROPERLY CONNECTED TO THE GROUNDING MAT.
- ALL EQUIPMENT NOT SHOWN BUT REQUIRED TO BE GROUNDED AS PER NPC SPECIFICATIONS SHALL BE CONNECTED TO THE GROUNDING MAT.
- 7. THE CONTRACTOR SHALL CARRY OUT THE EARTH RESISTIVITY MEASUREMENT AND THE RESULT SHALL BE USED IN THE GROUNDING GRID DESIGN AND CALCULATION TO BE SUBMITTED FOR NPC APPROVAL.

# LEGENDS:

- 100 MM. SQ. BARE STRANDED COPPER

- GROUND ROD CONNECTION

- CROSS-WELD CONNECTION

- T-WELD CONNECTION

- WELD CONNECTION OF EQPT. TO GROUNDING MAT.

- SECLUSION FENCE

TEST PIT



NATIONAL POWER CORPORATION
GABRIEL Y, ITCHON BLDG, SEN, MIRIAM P, DEFENSOR-SANTIAGO
AVENUE (FORMERLY BIR ROAD) CORNER OUEZON AVENUE,

PROJECT: SUPPLY, DELIVERY, CONSTRUCTION, INSTALLATION, TESTING AND COMMISSIONING OF 10MYA MASBATE (MALINTA) SUBSTATION

LOCATION: MALINTA, MASBATE

TITLE:

**GROUNDING LAYOUT** 


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	∵BY	CHAO	-DATE	- Miniminal Continues of the Continues o
DESIGNED				SUBMITTED: R.P. VERAR
DRAWN				
REVIEWED	PRINCIPAL	ENGTL/AR	ICHT.	RECOMMENDED: G. Z. C. LUGOD JR.
CML/ARCHT				Hanager, EEICD
ELEC.				APPROVED: G. B. MAGPOC, JR.
MECH.				Manager, 000

DWG. NO. MSS-BDE-22.011

SPECS. NO. LuzP23Z1636Sce

BY CHKD. RECO. APPD. SCALE: 1:300

**BID DRAWING** 

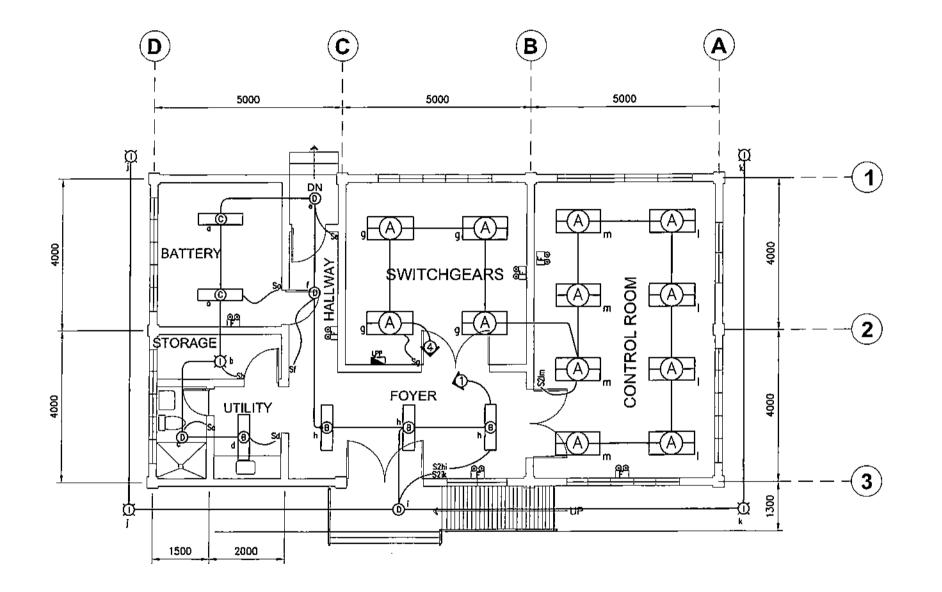

NATURE OF REVISION

# NOTES:

- FIXTURES AND CONDUIT RUNS ARE INDICATIVE ONLY. ACTUAL LOCATION OF RUNS SHALL BE DETERMINED IN THE FIELD.
- 2. ALL LIGHTING SWITCHES SHALL BE MOUNTED 1.37 m ABOVE FINISHED FLOOR.
- 3. JUNCTION BOXES SHALL BE PROVIDED WHENEVER DEEMED NECESSARY.
- ALL WIRES SHALL BE TYPE THHN/THWN-2 600 V INSULATION, STRANDED COPPER CONDUCTOR.
- 5. CONDUIT SHALL BE UPVC CLASS A, UNLESS OTHERWISE INDICATED.
- EMERGENCY LIGHTING SHALL BE CONNECTED TO 230Voc EMERGENCY LIGHTING OUTLET.
- SAMPLES OF MATERIALS AND LATEST CATALOGUE OF FIXTURES, ACCESSORIES AND EQUIPMENT SPECIFIED HEREIN SHALL BE SUBMITTED TO EEICD FOR VERIFICATION AND APPROVAL BEFORE PURCHASE AND INSTALLATION.
- 8. ALL WORKS SHALL CONFORM WITH THE LATEST PROVISIONS OF THE PHILIPPINE ELECTRICAL CODE.

# LEGEND:

⊟Ø⊢ - FIXTURE TYPE A - FIXTURE TYPE B - FIXTURE TYPE C 0 - FIXTURE TYPE D  $\mathfrak{Q}$ - FIXTURE TYPE I - FIXTURE TYPE F - 1-GANG SWITCH Sa - 2-GANG SWITCH Sbc LPP-A/PP-8 - LIGHTING/POWER PANEL BOARD CIRCUIT HOME RUN



# NATIONAL POWER CORPORATION

ABRIEL Y, ITCHON BLDG., SEN. MIRIAM P, DEFENSOR: SANTIAG AVENUE (FORMERLY BIR ROAD) CORNER QUEZON AVENUE, DILIMAN 1100 QUEZON CITY, PHEIPPINES

PROJECT: SUPPLY, DELIVERY, CONSTRUCTION, INSTALLATION, TESTING AND COMMISSIONING OF 10MVA MASBATE (MALINTA) SUBSTATION

LOCATION: MALINTA, MASHATE

TITLE:


### **CONTROL HOUSE LIGHTING LAYOUT**

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	· 8Y	CHKD	DATE		KAMPINE
DESIGNED				SUBMITTED:	R/P. VERAR
DRAWN				] -	4 600275
REVIEWED	PRINCIPA	L ENGR. / AF	RCHT.	RECOMMENDE	E. Z. C. LUGOD, JR.
CIVIL/ARCHT					Manager, EEICD
BLEC.				APPROVED:	G. B. MAGPOC, JR.
MECH			<u> </u>	<u> </u>	Manager, DOO

DWG. NO. MSS-BDE-22.012

SPECS. NO. LuzP23Z1636Sce

BY CHKD. RECD. APPD. SCALE: 1:100 BID DRAWING

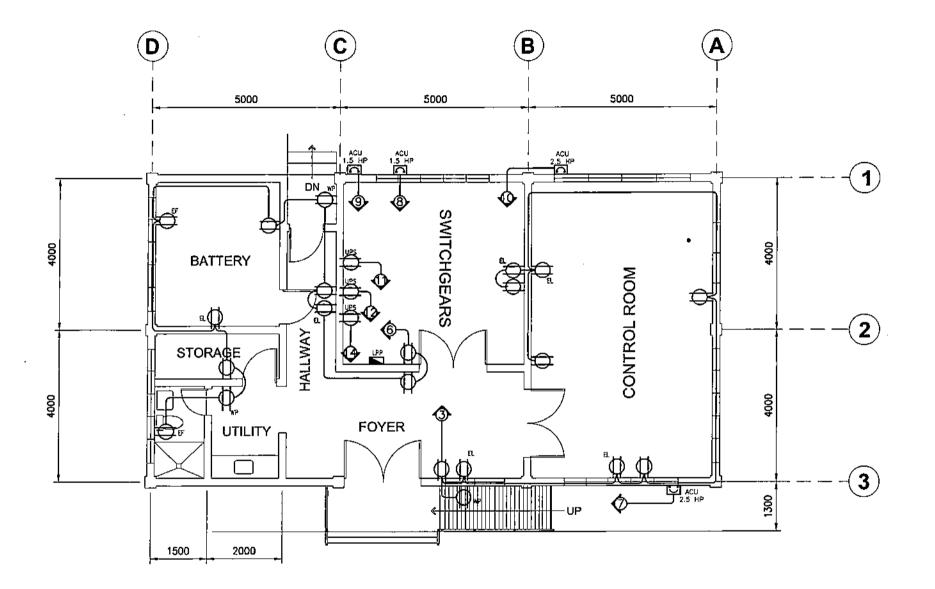

NATURE OF REVISION

# NOTES:

- CONVENIENCE OUTLETS AND CONDUIT RUNS ARE INDICATIVE ONLY. ACTUAL LOCATIONS AND RUNS SHALL BE DETERMINED IN THE FIELD.
- CONVENIENCE OUTLETS SHALL BE MOUNTED 0.3 m ABOVE FINISHED FLOOR EXCEPT FOR EXHAUST FAN OUTLET (EF) AND EMERGENCY LIGHT OUTLET (EL) WHICH SHALL BE DETERMINED IN THE FIELD.
- ALL WRES SHALL BE TYPE THHN/THWN-2 600 V INSULATION, STRANDED COPPER CONDUCTOR.
- 4. CONDUIT SHALL BE uPVC, CLASS A.
- ALL WORKS SHALL CONFORM WITH THE LATEST PROVISION OF THE PHILIPPINE ELECTRICAL CODE.

# LEGENDS:

F - EXHAUST FAN OUTLET (SINGLE OUTLET)

- EMERGENCY LIGHTING OUTLET (SINGLE OUTLET)

UPS OUTLET
(SINGLE OUTLET)

P — CONVENIENCE OUTLET, DUPLEX, 2 POLES, 230 V, 15 A FLUSH MOUNTED

- CONVENIENCE OUTLET, DUPLEX, 2 POLES, 230 V, 15 A, WEATHER PROOF TYPE

- LIGHTING & POWER PANEL BOARD

- ENCLOSED CIRCUIT BREAKER
- IN NEMA-3R ENCLOSURE



# NATIONAL POWER CORPORATION

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PROJECT: SUPPLY, DELIVERY, CONSTRUCTION, INSTALLATION, TESTING AND COMMISSIONING OF 10MVA MASBATE (MALINTA) SUBSTATION

LOCATION: MALINTA, MASBATE

TILE

# **CONTROL HOUSE POWER LAYOUT**


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	BY	— CHO-	- DATE	·	Ministry
DESIGNED				SUBMITTED:	Prince Engineer A 2010
DRAWN					(000 /
REVIEWED	PRINCIPAL	ENGR./AF	ICHT.	RECONDINENDE	
CIVILIARCHT					Manager, EEI80
ELEC.				APPROVED:	G. B. MAGPOC, JR.
MECH					Manager, ODO


DWG.NO. MSS-BDE-22.013

SPECS. NO. LuzP23Z1636Sce

BY CHKO. RECO. APPD. SCALE: 1:100

**BID DRAWING** 

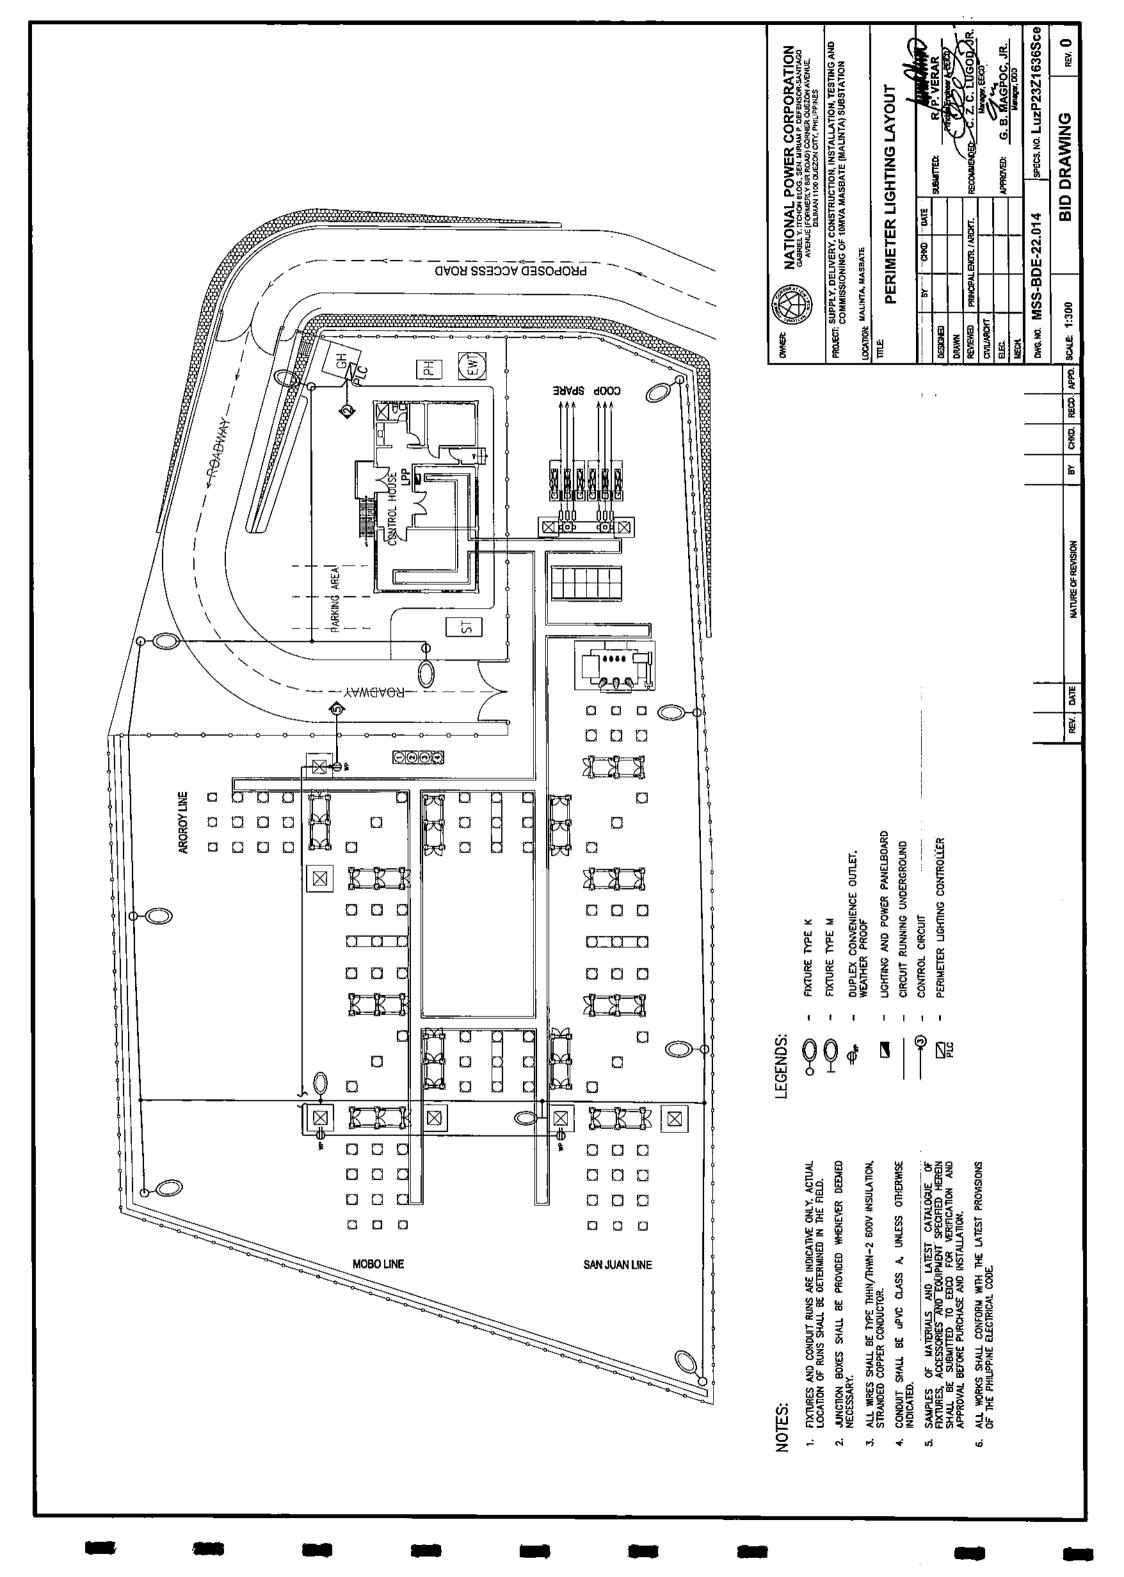

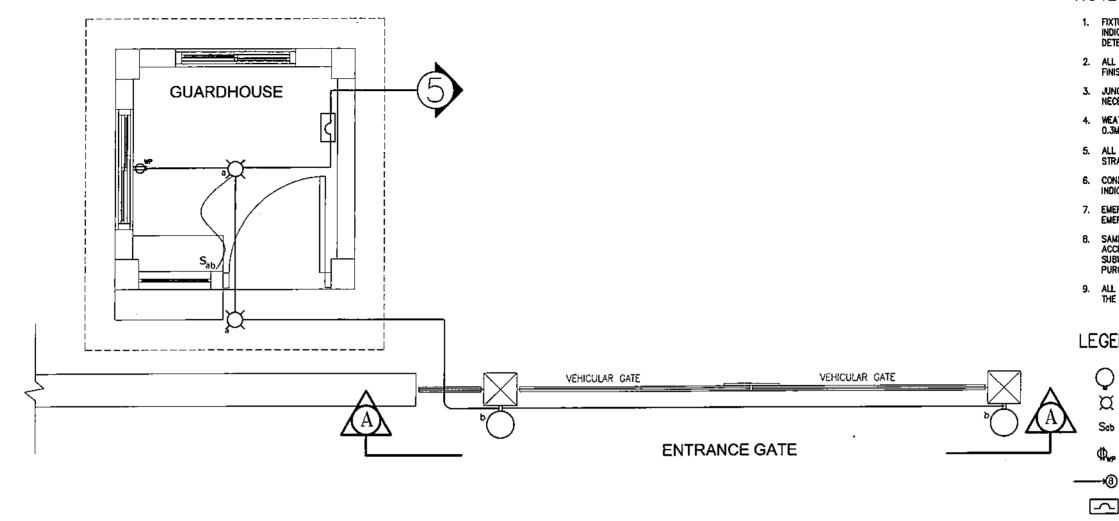

- 1. FIXTURES, CONVENIENCE OUTLET AND CONDUIT RUNS ARE INDICATIVE ONLY. ACTUAL LOCATION OF RUNS SHALL BE DETERMINED IN THE FIELD.
- 2. ALL LIGHTING SWITCHES SHALL BE MOUNTED 1.37 m ABOVE FINISHED FLOOR.
- 3. JUNCTION BOXES SHALL BE PROVIDED WHENEVER DEEMED NECESSARY.
- 4. WEATHER PROOF CONVENIENCE OUTLETS SHALL BE MOUNTED 0.3M ABOVE FINISHED GROUND LINE.
- ALL WIRES SHALL BE TYPE THHN/THWN-2 600V INSULATION, STRANDED COPPER CONDUCTOR.
- 6. CONDUIT SHALL BE UPVC CLASS A. UNLESS OTHERWISE
- 7. EMERGENCY LIGHTING SHALL BE CONNECTED TO 230Vqc EMERGENCY LIGHTING OUTLET.
- SAMPLES OF MATERIALS AND LATEST CATALOGUE OF FIXTURES, ACCESSORIES AND EQUIPMENT SPECIFIED HEREIN SHALL BE SUBMITTED TO EECO FOR VERIFICATION AND APPROVAL BEFORE PURCHASE AND INSTALLATION.
- ALL WORKS SHALL CONFORM WITH THE LATEST PROVISIONS OF THE PHILIPPINE ELECTRICAL CODE.

# LEGENDS:

- FIXTURE TYPE O


- FIXTURE TYPE 1


- 2-GANG SWITCH

- WEATHER PROOF CONVENIENCE OUTLET

- CIRCUIT RUN

SAFETY BREAKER, 20A, 2P, 230VAC

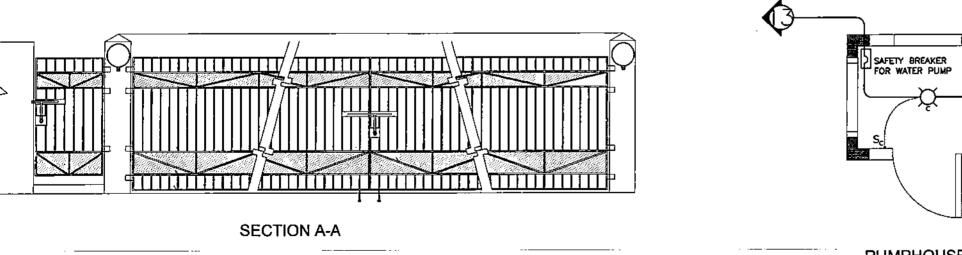

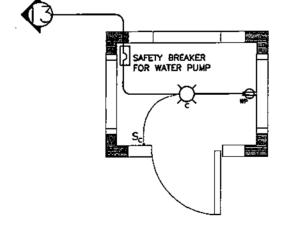

NATURE OF REVISION

REV. DATE

**PUMPHOUSE** 

BY CHRO. RECO. APPO.



**NATIONAL POWER CORPORATION** ABRIEL Y, ITCHON BLOG,, SEN. MIRIAM P. DEFENSOR-SANTAG AVENUE (FORMERLY BIR ROAD) CORNER QUEZON AVENUE, DILIMAN 1100 QUEZON CITY, PHILIPPINES

PROJECT: SUPPLY, DELIVERY, CONSTRUCTION, INSTALLATION, TESTING AND COMMISSIONING OF 10MVA MASBATE (MALINYA) SUBSTATION

LOCATION: MALINTA, MASBATE

GUARDHOUSE ENTRANCE GATE AND **PUMPHOUSE LIGHTING & POWER LAYOUT** 

	BY	CHO	DATE	I	
DESIGNED	_			SUBMITTED:	P. P. VERAR
DRAWN	i		_	1,	Personal Action
REVIEWED	PRONCIPA	L ENGTR / A	RCHT.	RECOMMENDE	
CIVILIARCHT				]	Menager, EEICO
BEC.		<u> </u>		APPROVED:	G. B. MAGPOC, JR.
MECH.		<u> </u>		]	Mirrager, 000

DWG. NO. MSS-BDE-22.015

SPECS, NO. LuzP23Z1636Sce

rev. O

**BID DRAWING** SCALE: NTS

			SCHEDUL	E OF LO	ADS					
СКТ	KT DESCRIPTION LOCATION		VA.	VA V	CURRENT (AMPERES)			SIZES		
NO.	DESCRIPTION	COCATION			AB	BC	CA	BREAKER	WIRE	CONDUIT
	2 - 1 x 16W FIXTURE TYPE C	BATTERY ROOM	}	ŀ						ı
	1 - 1 x 25W FIXTURE TYPE I	STORAGE ROOM	ļ					Ì		
	1 - 1 x 9W FIXTURE TYPE D	TOILET	<u> </u>				•			
1	1 - 1 x 9W FIXTURE TYPE D	TOILET	322	230	1.40			50AF / 15AT	2 - 3.5mm² THHN/THWN-2	20mmØ uPVC
•	2 - 1 x 9W FIXTURE TYPE D	CORRIDOR		200					, , , , , , , , , , , , , , , , , , , ,	
	4 - 1 x 16W FIXTURE TYPE B	FOYER / UTILITY								
	1 - 1 x 9W FIXTURE TYPE D	PORCH								
	4 - 1 x 25W FIXTURE TYPE I	CANOPY								, <u> </u>
_	2 - 1 x 30W FIXTURE TYPE M	PERIMETER &	330.00	230		1.43		50AF / 20AT	2 - 3.5mm² THHN/THWN-2	20mmØ uPVC
2	9 - 1 x 30W FIXTURE TYPE K	SWITCHYARD	330.00	200	<u></u>	1.13				
	5 - 200 VA DUPLEX CONVENIENCE OUTLET		!							
3	1 - 200 VA WEATHERPROOF CONVENIENCE OUTLET	SWITCHGEAR, CONTROL ROOM & FOYER	1220	230	5.30			50AF / 20AT	2 - 3.5mm <sup>3</sup> THHN/THWN-2 1 - 3.5mm <sup>3</sup> THHN/THWN-2	20mmØ uPVC
	4 - 2 X 2W EMERGENCY LIGHT OUTLET	7								
	4 - 2 x 16W FIXTURE TYPE A	SWITCHGEAR & AUX. ROOM	480	230	2.09			50AF / 15AT	2 - 3.5mm <sup>2</sup> THHN/THWN-2	20mmØ uPVC
4	8 - 2 x 16W FIXTURE TYPE A	CONTROL ROOM	700	230	2.05			JUNI 7 IUNI	Z = 0.0mm mmay man Z	
	5 - 200 VA WEATHERPROOF OUTLET	SWITCHYARD,	1025		4.46			50AF / 20AT	2 - 3.5mm <sup>1</sup> THHN/THWN-2 1 - 3.5mm <sup>1</sup> THHN/THWN-2	20mmØ uPVC
5	2 - 1 x 25W FIXTURE TYPE I	CUARDHOUSE & PUMPHOUSE		230			!			
	2 - 1 x 25W FIXTURE TYPE O	GATE				اِ				
	5 - 200 VA DUPLEX CONVENIENCE OUTLET							<u> </u>		
_	2 - 200 VA WEATHERPROOF CONVENIENCE OUTLET	FOYER, BATTERY ROOM	4740	070		7.47		50AF / 20AT	2 - 3.5mm² THHN/THWN-2	20mmØ uPVC
6	2 - 2 X 2W EMERGENCY LIGHT OUTLET	STORAGE	1710	230		7.43		30AF / 20A1	1 - 3.5mm <sup>3</sup> THHN/THWN-2	2011/1110 11740
	2 - 100VA EXHAUST FAN OUTLET	]								
7	1 - 2.5 HP AIR CONDITIONING UNIT	CONTROL/RELAY ROOM	3335	230			14.50	50AF / 40AT	2 - 5.5mm² THHN/THWN-2 1 - 5.5mm² THHN/THWN-2	20mmØ uPVC
8	1 - 1.5 HP AIR CONDITIONING UNIT	SWCR/AUX ROOM	2300	230			10.00	50AF / 25AT	2 - 5.5mm2 THHN/THWN-2 1 - 5.5mm2 THHN/THWN-2	20mmØ uPVC
9	1 - 1.5 HP AIR CONDITIONING UNIT	SWGR/AUX ROOM	2300	230	10.00			50AF / 25AT	2 - 5.5mm* THHN/THWN-2	20mmØ uPVC
10	1 - 2.5 HP AIR CONDITIONING UNIT	CONTROL/RELAY ROOM	3335	230		14.50		50AF / 40AT	1 - 5.5mm² THHN/THWN-2 2 - 5.5mm² THHN/THWN-2	20mmØ uPVC
11	500 VA UPS OUTLET FOR TELEPHONE EQUIPMENT	CONTROL ROOM	500	230	2.17			50AF / 20AT	1 - 5.5mm² THHN/THWN-2 2 - 3.5mm² THHN/THWN-2	20mmØ uPVC
	-					2.83		50AF / 20AT	1 - 3.5mm² THHN/THWN-2 2 - 3.5mm² THHN/THWN-2	20mmØ uPVC
12	650 VA UPS OUTLET FOR CCTV SYSTEM	SWGR/AUX ROOM	650	230		4.00		50AF / 20AT	1 - 3.5mm <sup>2</sup> THHN/THWN-2 2 - 3.5mm <sup>3</sup> THHN/THWN-2	20mmØ uPVC
13	PUMPHOUSE LOADS	PUMPHOUSE	1598.25	230	6.95	,	<u> </u>		1 - 3.5mm² THHN/THWN-2 2 - 3.5mm² THHN/THWN-2	·
14	1000 VA UPS OUTLET FOR VSAT	CONTROL ROOM	1000	230	<u> </u>	4.35		50AF / 20AT	1 - 3.5mm <sup>1</sup> THHN/THWN-2	20mmØ uPVC
15	SPARE		1500	230			6.52	50AF / 20AT	· <del>-</del> -	<u>-</u>
16	SPACE						<u> </u>		<u> </u>	<u> </u>
	TOTAL	<u>l</u>	20105.25	230	32.37	30.54	31.02			


PROVIDE: 100AF / 60AT, 3P MCCB WITH BRANCH CIRCUITS OF: 2 - 50AF/40AT, 2P, MCB

2 - 50AF/25AT, 2P, MCB 9 - 50AF/20AT, 2P, MCB 2 - 50AF/15AT, 2P, MCB

PROVIDE: 3 - 14mm2 THN/THWN-2 Copper Conductor & 1 - 8.0mm² THHN/THWN-2 Copper Conductor in 25mmø uPVC Conduit

#### RISER DIAGRAM LIGHTING & POWER PANEL

(TO 230VAC, LOW VOLTAGE PANEL FEEDER NO. 1)

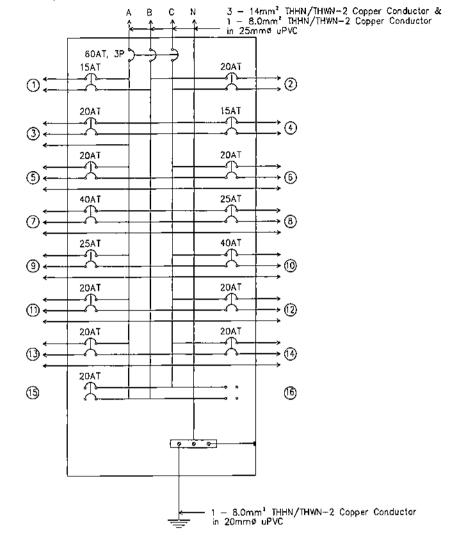



NATIONAL POWER CORPORATION
GABRIEL Y, ITCHON BLDG., SEN, MIRIAM P. DEFENSOR-SANTIAGO
AVENUE (FORMERLY BIR ROAD) CORNER QUEZON AVENUE,
DILIMAN 1100 QUEZON CITY, PHILIPPINES

PROJECT: SUPPLY, DELIVERY, CONSTRUCTION, INSTALLATION, TESTING AND COMMISSIONING OF 10MVA MASBATE (MALINTA) SUBSTATION

LOCATION: MALINTA, MASBATE

LOAD SCHEDULE & RISER DIAGRAM OF LPP

	8Y	CHAD	DATE		_
DESIGNED				SUBMITTED:	- Print
DRAWN	MURP F			]	W
REVIEWED	PRINCIPAL	ENGR/AR	ICHT.	RECOMMENDE	D.C. Z.
CIVIL/ARCHT				}	
RLEC.				APPROVED:	G. B.
VECH.					


MAGPOC, JR. Naneger, 000

DWG. NO. MSS-BDE-22.016

SPECS. NO. LuzP23Z1636Sce

BY CHROD RECO. APPO. SCALE: N.T.S. REV. DATE NATURE OF REVISION

**BID DRAWING** 

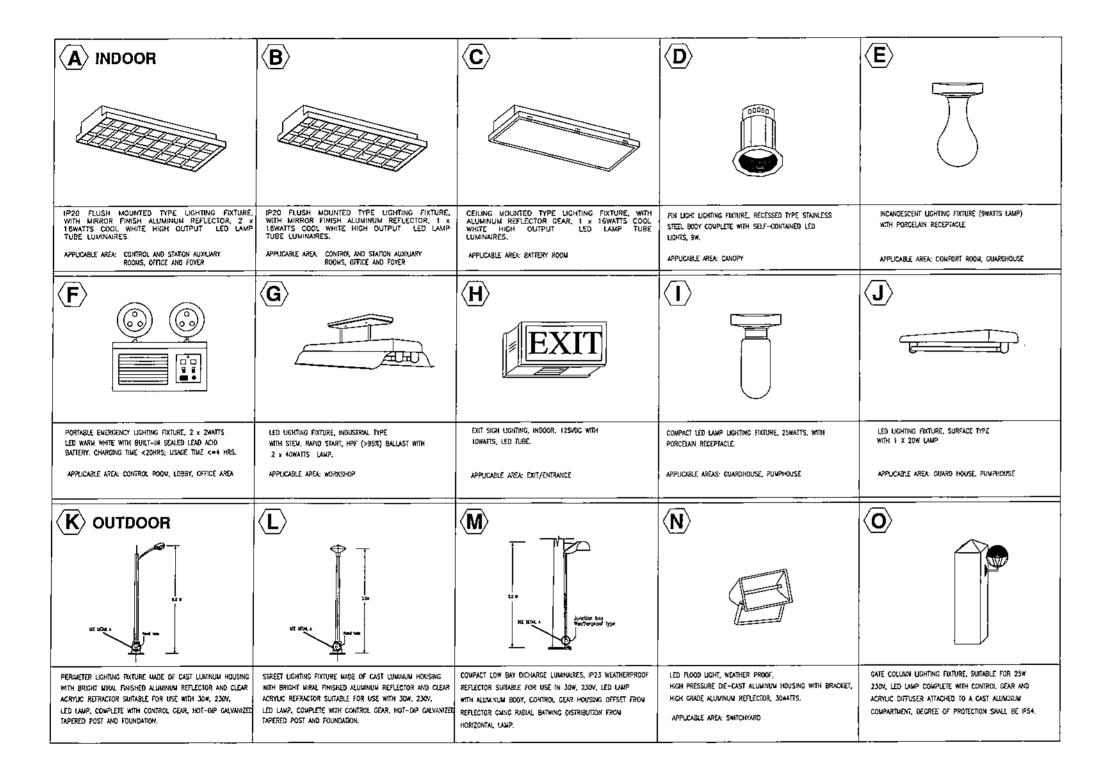

NATURE OF REVISION



# NATIONAL POWER CORPORATION GABRIELY, ITCHON BLDG., SEN. MIRIAM P. DEFENSOR-SANTIAGO AVENUE (FORMERLY BIR ROAD) CORNER QUEZON AVENUE, DILIMAN 1100 QUEZON CITY, PHILIPPINES

PROJECT: SUPPLY, DELIVERY, CONSTRUCTION, INSTALLATION, TESTING AND COMMISSIONING OF 10MVA MASBATE (MALINTA) SUBSTATION

LOCATION: MALINTA, MASBATE

TITLE:

# LIGHTING FIXTURE DETAILS

	BY	CHKD	DATE		
ESIGNED			[	SUBMITTED:	R/P. VERAR
RAWN	MURR				to univiluit
EVIEWED	PRINCIPAL ENGR. / ARCHT.			RECOMMENDE	DC. Z. C/LUGOD, JR.
MILIARCHT					Minager, EEICO
LEC.				APPROVED:	G. B. MAGPOC, JR.
ECH.					Manager, DOD

DWG. NO. MSS-BDE-22.017


SPECS, NO. LuzP23Z1636Sce

REV. O

BY CHKD. RECO. APPD. SCALE: N.T.S.

**BID DRAWING** 

1. PERIMETER LIGHTING CONTROLLER AS SHOWN SHALL BE INSTALLED INSIDE THE GUARD HOUSE. ALTERNATIVE CONTROLLER MAY BE SUGGESTED/RECOMMENDED BY THE SUPPLIER PROVIDE THAT MANUAL AND AUTOMATIC CONTROL STILL, INCLUDED AND SUBJECT TO NPC REVIEW AND

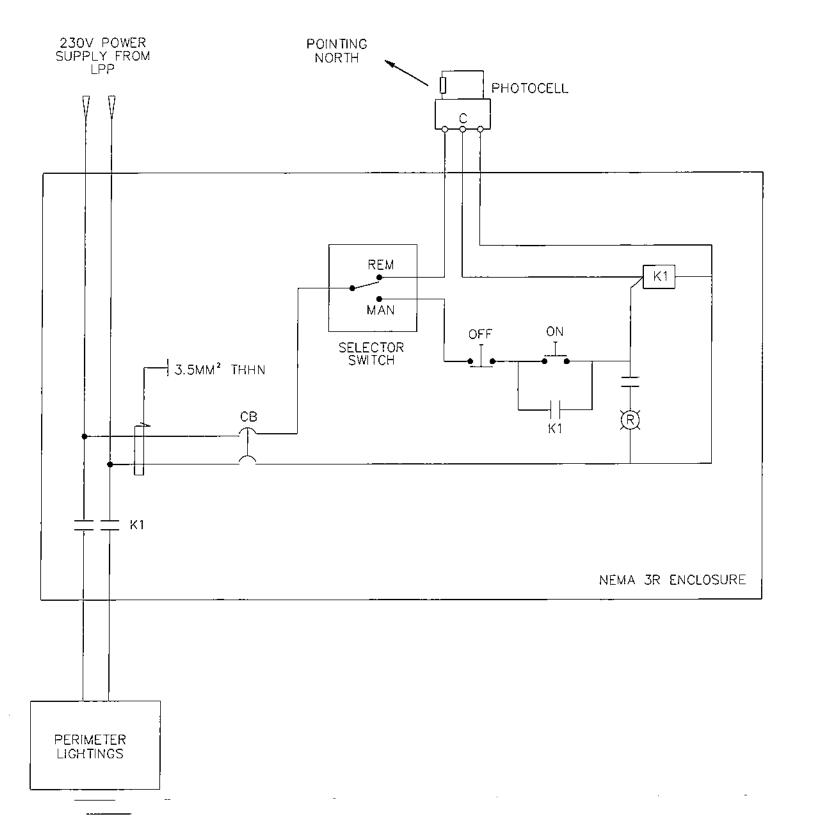

PERIMETER LIGHTING CONTROLLER

REV. DATE

NATURE OF REVISION

CHKD DATE BY ILLRP \*\* PRINCIPAL ENGR. / ARCHT. G. BAMAGPOC, JR.
Manager, DOD

DESIGNED DRAWN REVIEWED CIVILIARCHT ELEC.

DWG. NO. MSS-BDE-22.018

LOCATION: MALINTA, MASBATE

me:

MECH.


SPECS, NO. LuzP23Z1636Sce


NATIONAL POWER CORPORATION
GABRIEL Y, ITCHON BLDG, SEN, MIRIAM P. DEFENSOR-SANTIAGO
AVENUE (FORMERLY BIR ROAD) CORNER QUEZON AVENUE,
DILIMAN 1100 QUEZON CITY, PHILIPPINES

PROJECT: SUPPLY, DELIVERY, CONSTRUCTION, INSTALLATION, TESTING AND COMMISSIONING OF 10MVA MASBATE (MALINTA) SUBSTATION

PERIMETER LIGHTING CONTROLLER

**BID DRAWING** BY CHKO. RECO. APPD. SCALE: N.T.S.

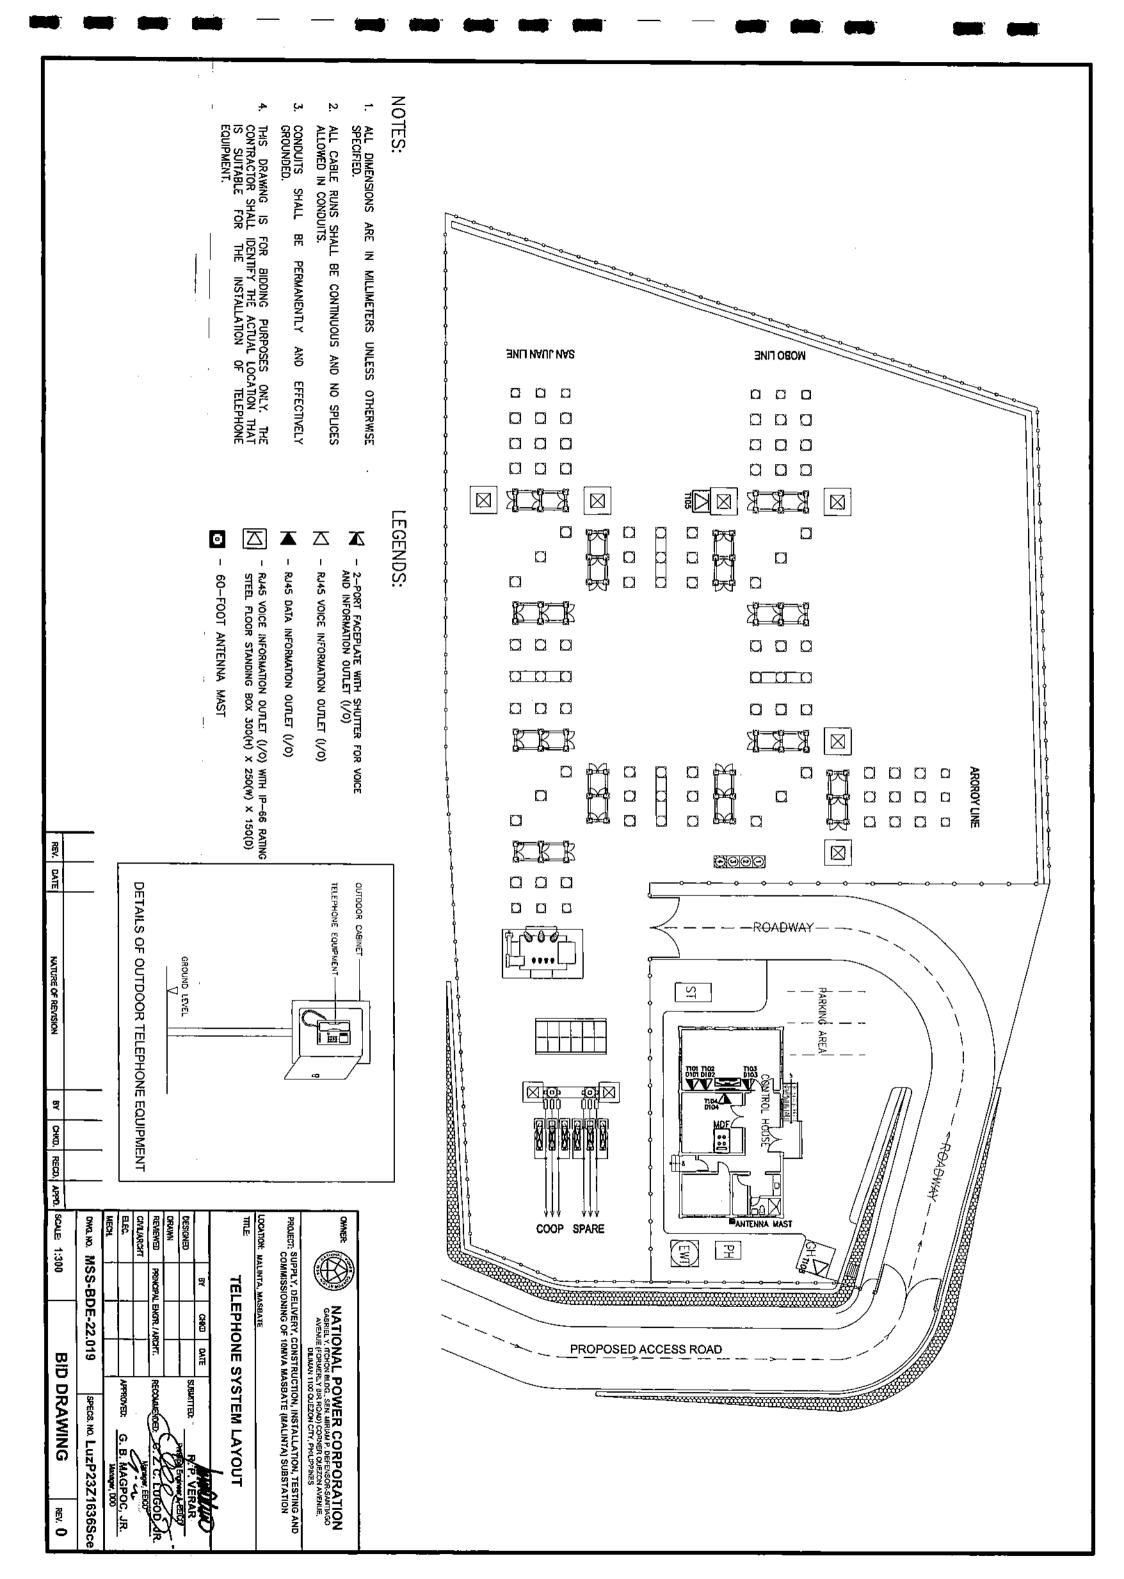

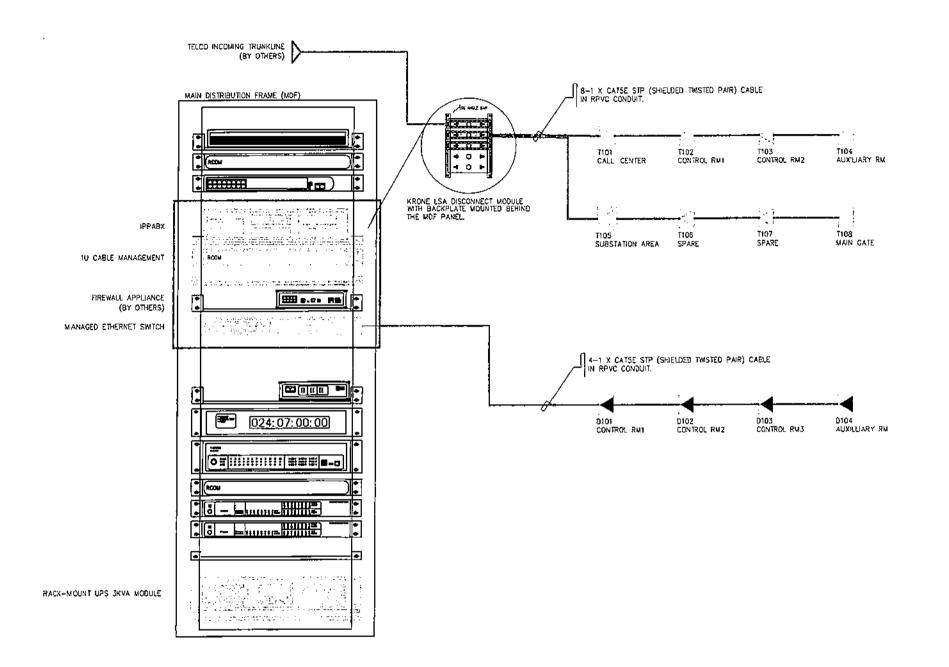

**VOICE AND DATA SYSTEM RISER DIAGRAM** 

BY CHOO. RECO. APPO. SCALE: N. T. S. REV. DATE NATURE OF REVISION

LEGENDS:

- 3-TRUNKLINE X 8-LOCAL IPPABX

- 10 CABLE DUCT

- 24-PORT GIGABIT MANAGEABLE SWITCH

- 2-PORT FACEPLATE WITH SHUTTER FOR VOICE AND INFORMATION OUTLET (I/O)

7 - RJ45 VOICE INFORMATION OUTLET (I/O)

← RJ45 DATA INFORMATION OUTLET (I/O)

- RJ45 VOICE INFORMATION OUTLET (I/O) WITH IP-66 RATING STEEL FLOOR STANDING BOX 300(H) X 250(W) X 150(D)



- KRONE LSA DISCONNECT MODULE WITH BACKPLATE



- RACK-MOUNT UPS 3KVA MODULE

# NOTES:

- 1. ALL CABLE RUNS SHALL BE CONTINUOUS AND NO SPLICES ARE ALLOWED IN CONDUITS AND CABLE TRAYS.
- 2. VOICE CABLE RUNS SHALL BE TERMINATED DIRECTLY TO THE KRONE LSA TERMINAL.
- 3. DATA CABLE RUNS SHALL BE TERMINATED DIRECTLY TO THE ETHERNET SWITCH.



NATIONAL POWER CORPORATION
GABRIEL Y, ITCHON BLDG., SEN, MIRIAM P, DEFENSOR-SANTIAGO
AVENUE (FORMERLY BIR ROAD) CORNER CUEZON AVENUE,
DILBIAN 1100 CUEZON CITY, PHILIPPINES

PROJECT: SUPPLY, DELIVERY, CONSTRUCTION, INSTALLATION, TESTING AND COMMISSIONING OF 10NVA MASBATE (MALINTA) SUBSTATION

LOCATION: MALINTA, MASBATE

# **VOICE AND DATA SYSTEM RISER DIAGRAM**

	BY	СНКО	DATE		R. P. VERAR
DESIGNED				SUBMITTED:	Pringle Engineer A, SECT
DRAWN	MURP				The business of the second
REVIEWED	PRINCIPAL ENG'R, / ARCHT.			RECOMMENDE	c.¢. z. c./EUGOD, JR.
CIVIL/ARCHT					Manager, EEICO
ELEC.				APPROVED:	G. B. MAGPOC, JR.
MECH					Manager, 000


DWG. NO. MSS-BDE-22.020


SPECS, NO. LuzP23Z1636Sce

**BID DRAWING** 

REV. O

1 01

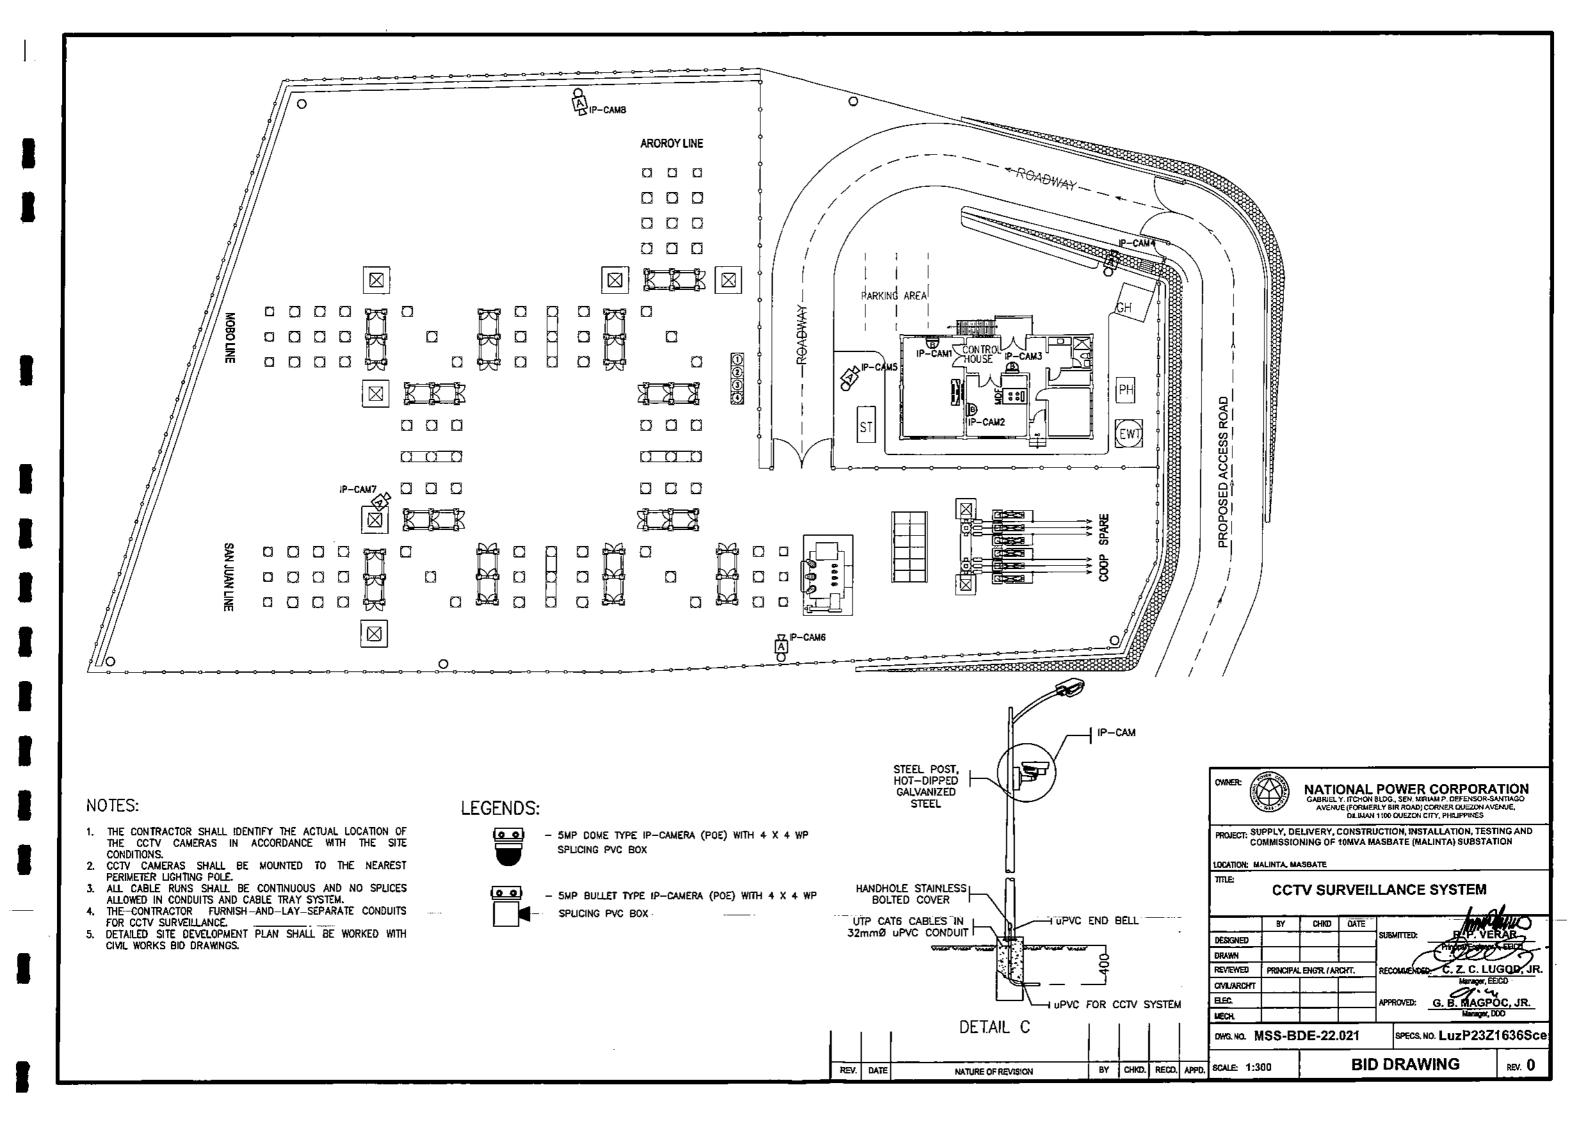

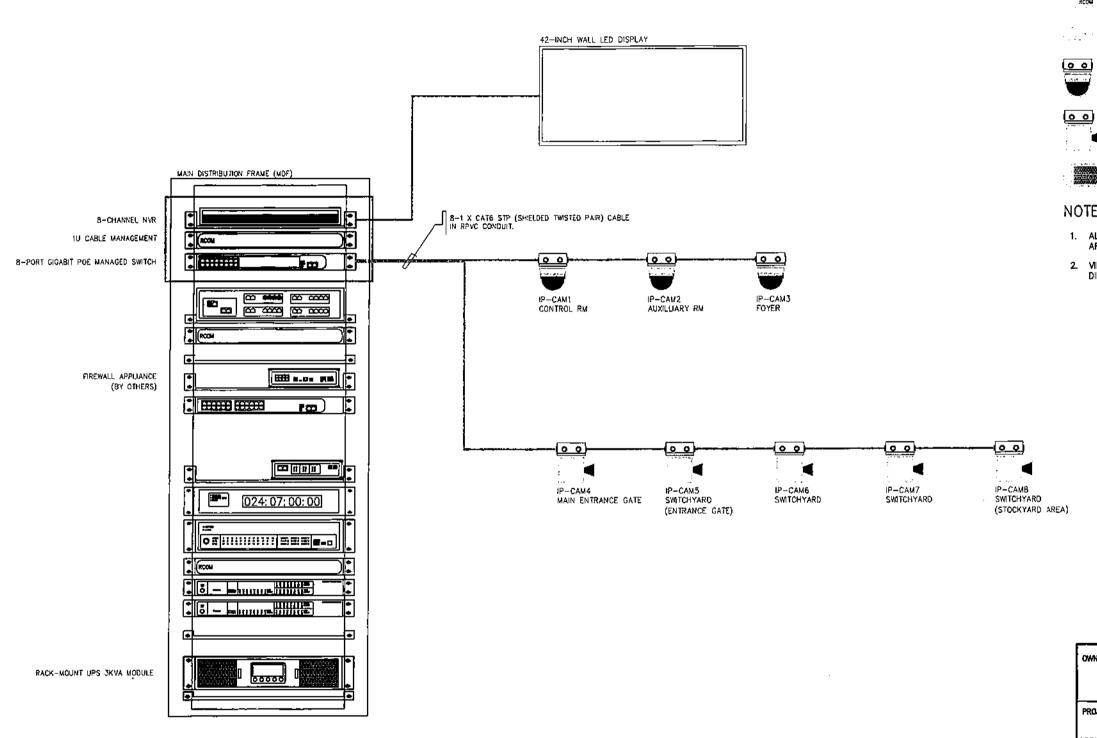

VIDEO SURVEILLANCE SYSTEM RISER DIAGRAM

REV. DATE

NATURE OF REVISION

### LEGENDS:

- 8-CHANNEL NETWORK VIDEO RECORDER (NVR) 2 - 1 X 8TB NAS DRIVE

- 10 CABLE DUCT

- 8-PORT GIGABIT POE MANAGED SWITCH

- 5MP DOME TYPE IP-CAMERA (POE) WITH 4 X 4 WP SPLICING PVC BOX



OO - SMP BULLET TYPE IP-CAMERA (POE) WITH 4 X 4 WP SPLICING PVC BOX



- RACK-MOUNT UPS 3KVA MODULE

# NOTES:

- ALL CABLE RUNS SHALL BE CONTINUOUS AND NO SPLICES ARE ALLOWED IN CONDUITS AND CABLE TRAYS.
- 2. VIDEO SURVEILLANCE CABLE RUNS SHALL BE TERMINATED DIRECTLY TO THE POE ETHERNET SWITCH.

NATIONAL POWER CORPORATION
GABRIEL Y. ITCHON BLDG., SEN, MIRIAM P, DEFENSOR-SANTIAGO
AVENUE (FORMERLY BIR ROAD) CORNER QUEZON AVENUE,
DILIMAN 1100 QUEZON CITY, PHILIPPINES

PROJECT: SUPPLY, DELIVERY, CONSTRUCTION, INSTALLATION, TESTING AND COMMISSIONING OF 10MVA MASBATE (MALINTA) SUBSTATION

LOCATION: MALINTA, MASBATE

TITLE:


### VIDEO SURVEILLANCE SYSTEM RISER DIAGRAM

	BY	CHKD	DATE		
DESIGNED				SUBMITTED:	R/P. VERAR
DRAWN	LURP (A			]	Principal Englises A. SECS
REVIEWED	PRINCIPAL ENGIR. / ARCHT.			RECOMMENDE	D. C. Z. C. LUGOD, JR.
CIVIL/ARCHT	/				Markeyer, SEICO
BLEC				APPROVED:	G. B. MAGPOC, JR.
MECH.				<u> </u>	Manager, DOD

DWG. NO. MSS-BDE-22.022

SPECS, NO. LuzP23Z1636Sce

**BID DRAWING** BY CHKO, RECO. APPD. SCALE: N.T.S.

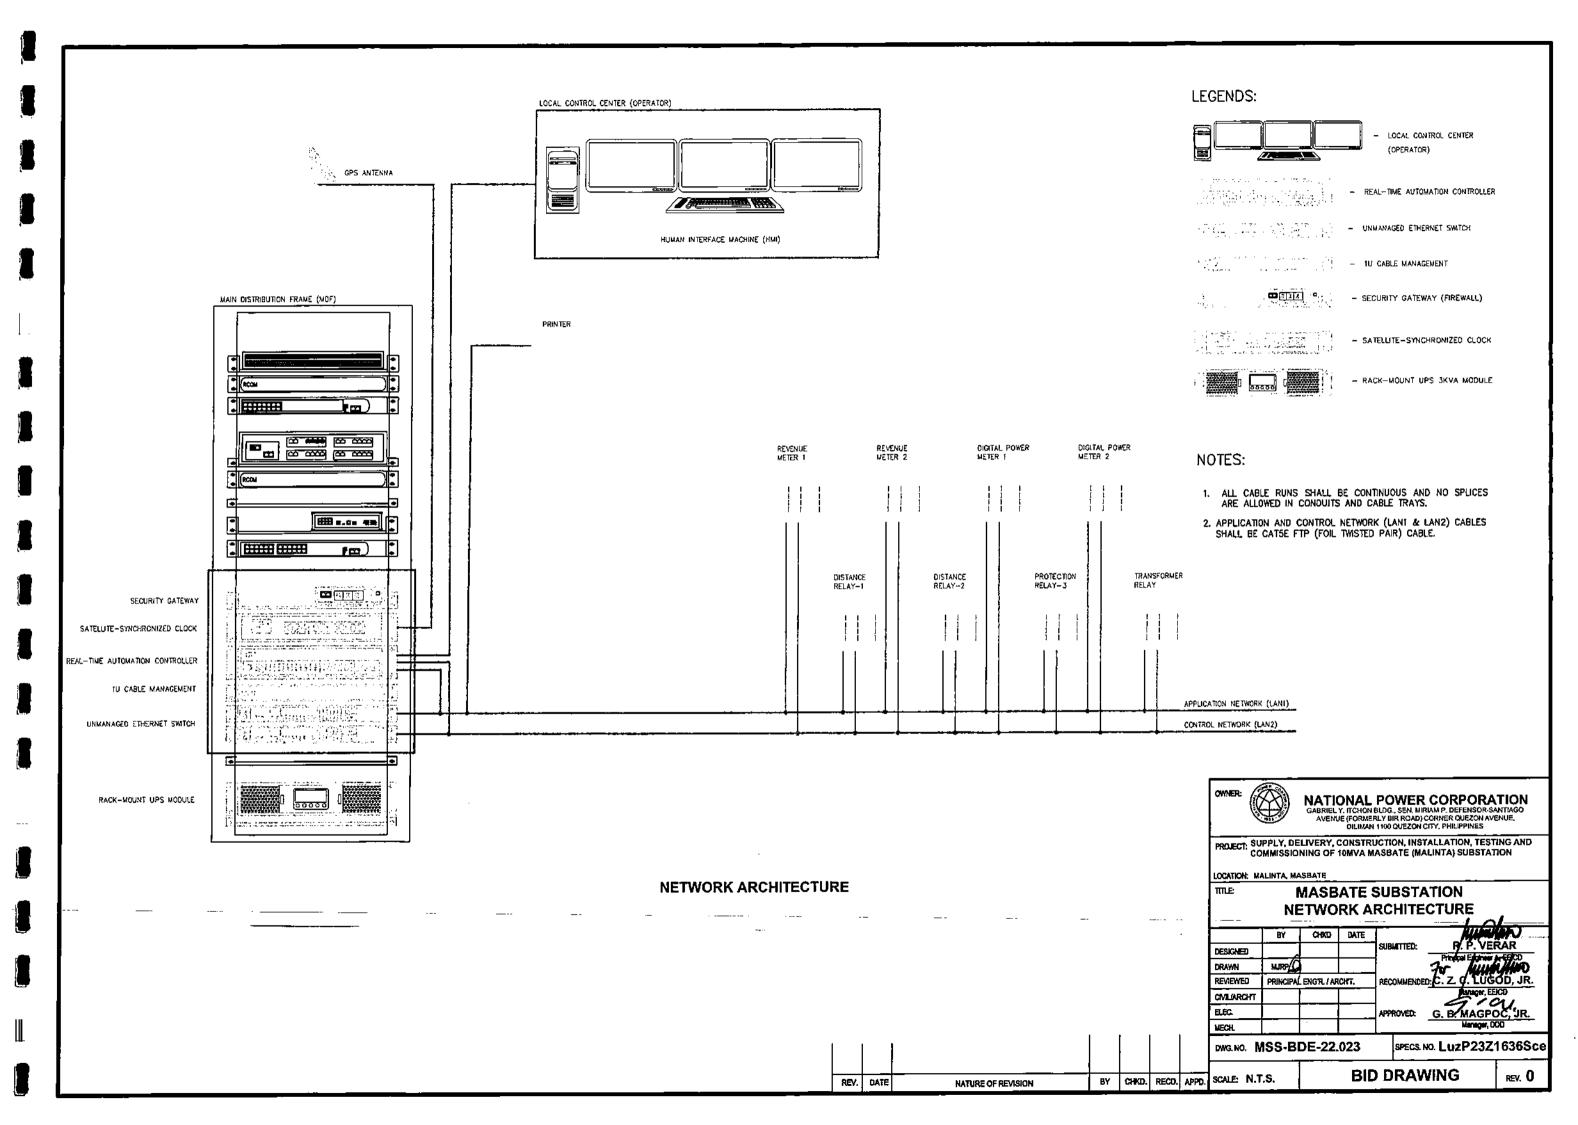



LuzP23Z1636Sce

# **SECTION IX - BID DRAWINGS**

# **MW - MECHANICAL DRAWINGS**

DRAWING NO.	TITLE
MSS-BDM-22.001	DOMESTIC WATER PIPING LAYOUT (MASBATE SUBSTATION)
MSS-BDM-22.002	AIRCONDITIONING, VENTILATION AND FIRE FIGHTING SYSTEM
MSS-BDM-22.003	DOMESTIC WATER SYSTEM (P & I DIAGRAM)
MSS-BDM-22.004	DEEP WELL DETAILS
MSS-BDM-22.005	ELEVATED WATER STORAGE TANK

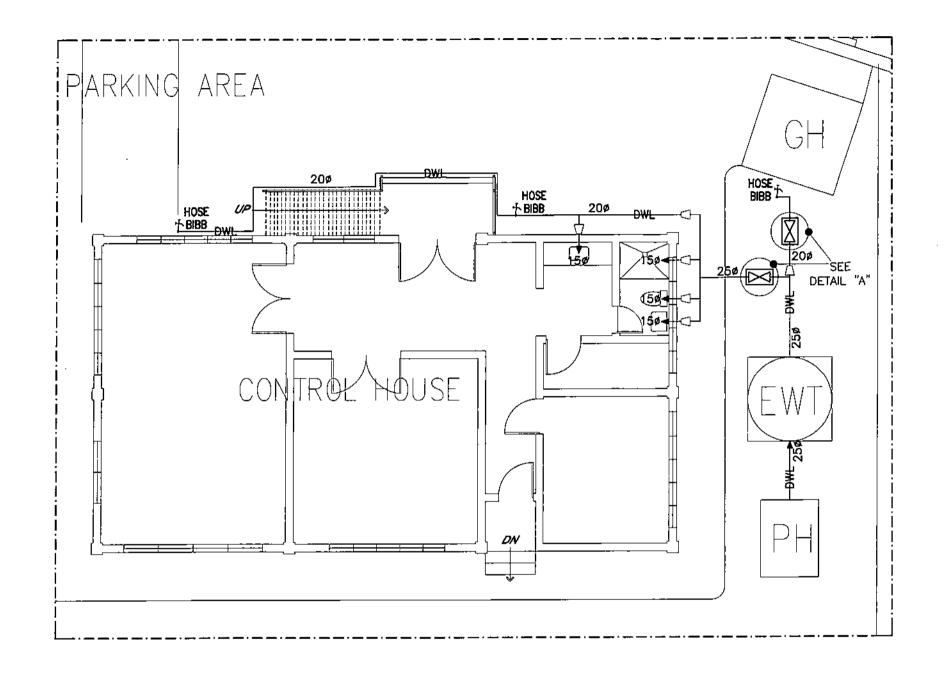

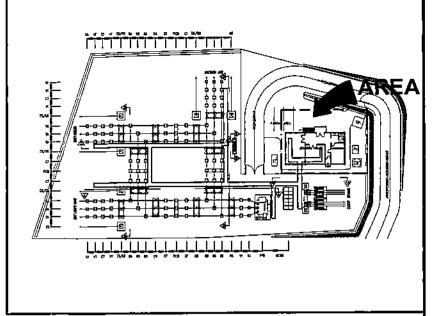

1. THIS DRAWING IS FOR BIDDING PURPOSES ONLY.
2. ALL DIMENSIONS ARE IN MILLIMETERS UNLESS OTHERWISE SPECIFIED.

3. EQUIPMENT TO BE FURNISHED SHALL BE DESIGNED & CONSTRUCTED IN ACCORDANCE WITH THE REQUIREMENTS OF THE SPECIFICATIONS & SHALL FIT INTO THE SPACE AVAILABLE WITH PROPER REGARD TO ACCESSIBILITY, PASSAGEWAY, HANDLING AND STRUCTURE LIMITATIONS.

4. ALL WORKS SHALL BE DONE IN ACCORDANCE WITH THE REQUIREMENTS

OF THE TECHNICAL SPECIFICATIONS.

5. PIPING SHALL BE EMBEDDED NOT LESS THAN 300MM FROM THE GROUND SURFACE TO THE BOTTOM OF PIPE.

6. FOR PIPES THAT CROSSES ROADWAYS, PIPE SLEEVE OF STEEL MATERIAL SHALL BE PROVIDED.

7. ALL PIPES, VALVES, VALVE BOXES, FITTINGS, AND PIPE SUPPORTS SHALL BE INSTALLED FOR THE EFFICIENT AND PROPER OPERATION OF THE

8. ALL PIPES AND VALVES' BROCHURES/CATALOGUES SHALL BE SUBMITTED BY THE CONTRACTOR, FOR NPC'S REVIEW AND APPROVAL, PRIOR TO PROCUREMENT/INSTALLATION.

9. FINAL DETAILS AND ADJUSTMENT SHALL BE DONE IN THE FIELD BY THE CONTRACTOR DURING INSTALLATION TO SUIT ACTUAL SITE CONDITIONS. ALL WORKS SHALL BE EXECUTED IN CLOSE COORDINATION WITH ALL

10. ALL upvc/PE PIPE DIMENSIONS SHOWN ARE IN NOMINAL DIAMETER (MM) WITH THE FOLLOWING EQUIVALENTS:

32MM (1 1/4") = 40MM OUTSIDE DIAMETER (O.D.)

25MM (1") = 32MM O.D. 20MM (3/4") = 25MM O.D.

OWNER:

15MM (1/2") ⇒ 20MM 0.0.

# LEGEND:

- HOSE BIBB

O - REDUCER


DWL - DOMESTIC WATER SUPPLY LINE

- PUMP HOUSE

- GATE VALVE

- ELEVATED WATER TANK

- GUARD HOUSE

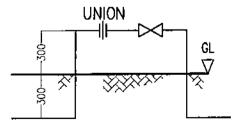

"ISOLATION VALVE"

DETAIL "A"

BY CHKO. RECO. APPO. REV. CATE NATURE OF REVISION

LOCATION: MALINTA, MASBATE DOMESTIC WATER PIPING LAYOUT TITLE: (MASBATE SUBSTATION) BY CHIOD DATE DESIGNED JAB, JUD T

PROJECT: SUPPLY, DELIVERY, CONSTRUCTION, INSTALLATION, TESTING AND COMMISSIONING OF 10MVA MASBATE (MALINTA) SUBSTATION

ORAYYN REVIEWED PRINCIPAL ENGTR / ARCHT. CIVILIARCHT ELEC. , KEBM MECH.

DWG. NO. MSS-BDM-22.001


SPECS, NO. LuzP23Z1636Sce

NATIONAL POWER CORPORATION
GABRIEL Y. MCHON BLOG., SEN. MIRIAM P. DEFENSOR-SANTIAGO
AVENUE (FORMERLY BIR ROAD) CORNER QUEZON AVENUE,
DILIMAN 1100 QUEZON CITY, PHILIPPINES

**BID DRAWING** SCALE: NTS

REV. 0

G. B. MAGPOC, JR

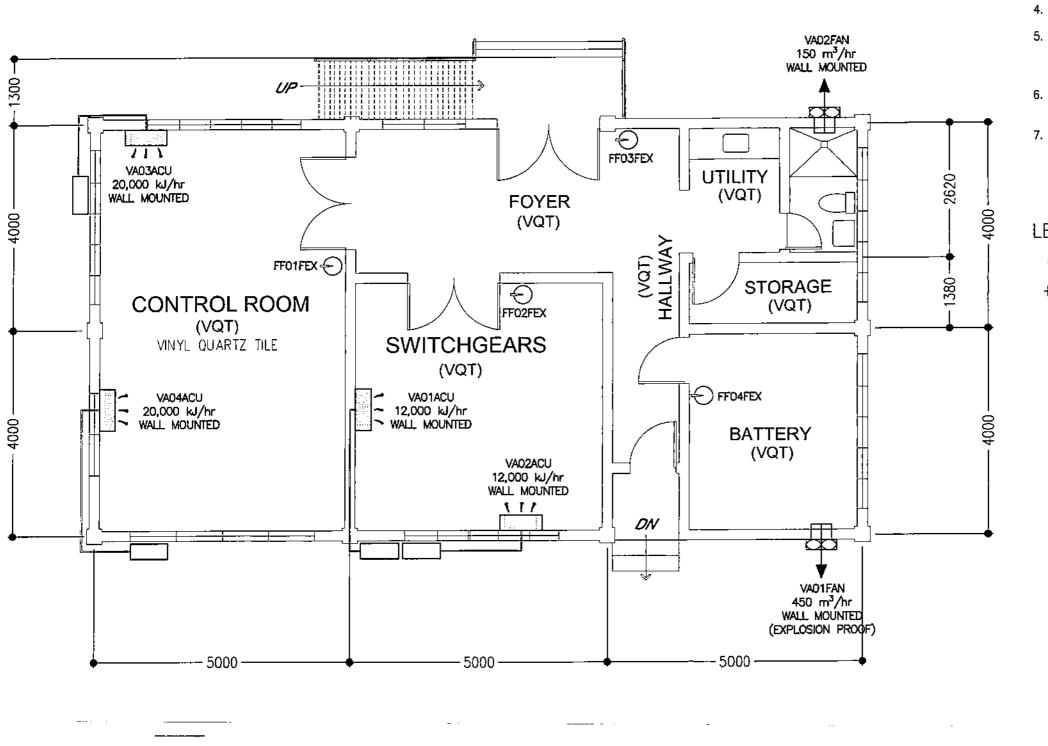


- 1. THIS DRAWING IS FOR BIDDING PURPOSES ONLY.
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- 3. EQUIPMENT TO BE FURNISHED SHALL BE DESIGNED & CONSTRUCTED IN ACCORDANCE WITH THE REQUIREMENTS OF THE SPECIFICATIONS & SHALL FIT INTO THE SPACE AVAILABLE WITH PROPER REGARD TO ACCESSIBILITY, PASSAGEWAY, HANDLING AND STRUCTURE LIMITATIONS.
- ALL WORKS SHALL BE DONE IN ACCORDANCE WITH THE REQUIREMENTS OF THE TECHNICAL SPECIFICATIONS.
- 5. ALL EXHAUST FAN AND AIRCONDITIONING EQUIPMENT BROCHURES/CATALOGUES SHALL BE SUBMITTED BY THE CONTRACTOR, FOR NPC'S REVIEW AND APPROVAL, PRIOR TO PROCUREMENT/INSTALLATION.
- 6. ALL PIPES, CABLES, FITTINGS, AND ANGLE SUPPORTS SHALL BE INSTALLED FOR THE EFFICIENT AND PROPER OPERATION OF THE AIRCONDITIONING SYSTEM.
- 7. FINAL DETAILS AND ADJUSTMENT SHALL BE DONE IN THE FIELD BY THE CONTRACTOR DURING INSTALLATION TO SUIT ACTUAL SITE CONDITIONS, ALL WORKS SHALL BE EXECUTED IN CLOSE COORDINATION WITH ALL TRADES.

# LEGEND:

二二 - SPLIT INVERTER TYPE AIR CONDITIONING UNIT

- EXHAUST FAN (WALL MOUNTED)

- PORTABLE FIRE EXTINGUISHER WALL-HUNG TYPE (HCFC OR HALOTRON)

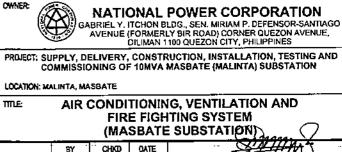

DESIGNED JAB SUBMITTED: N. G. ESPAYOS
DRAWN JAB SUBMITTED: N. G. ESPAYOS
PROBELEGION A
REVIEWED PRINCIPAL ENGR. / ARCHT.
CAVILLARCHT
ELEC. APPROVED: G. B. MAGPOC, JR
Manager, DOD

DWG.NO. MSS-BDM-22.002

SPECS. NO. LuzP23Z1636Sce


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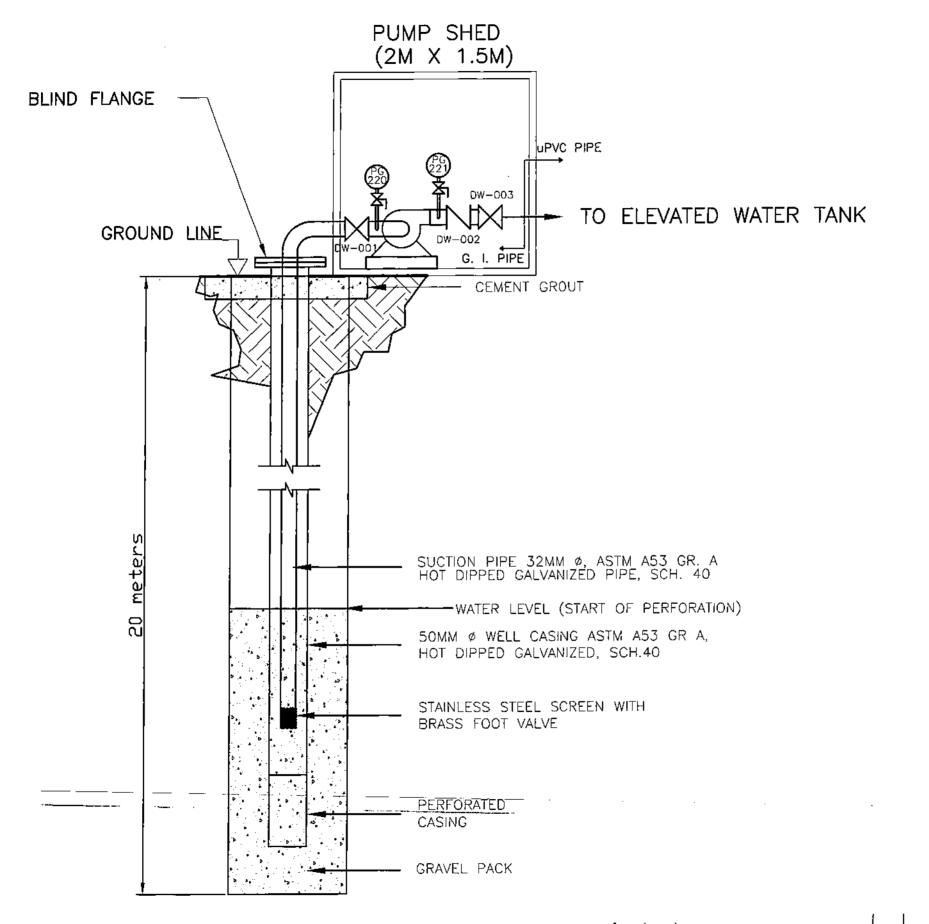
BY CHKD. RECO. APPO.

NATURE OF REVISION

BID DRAWING

REV. 0



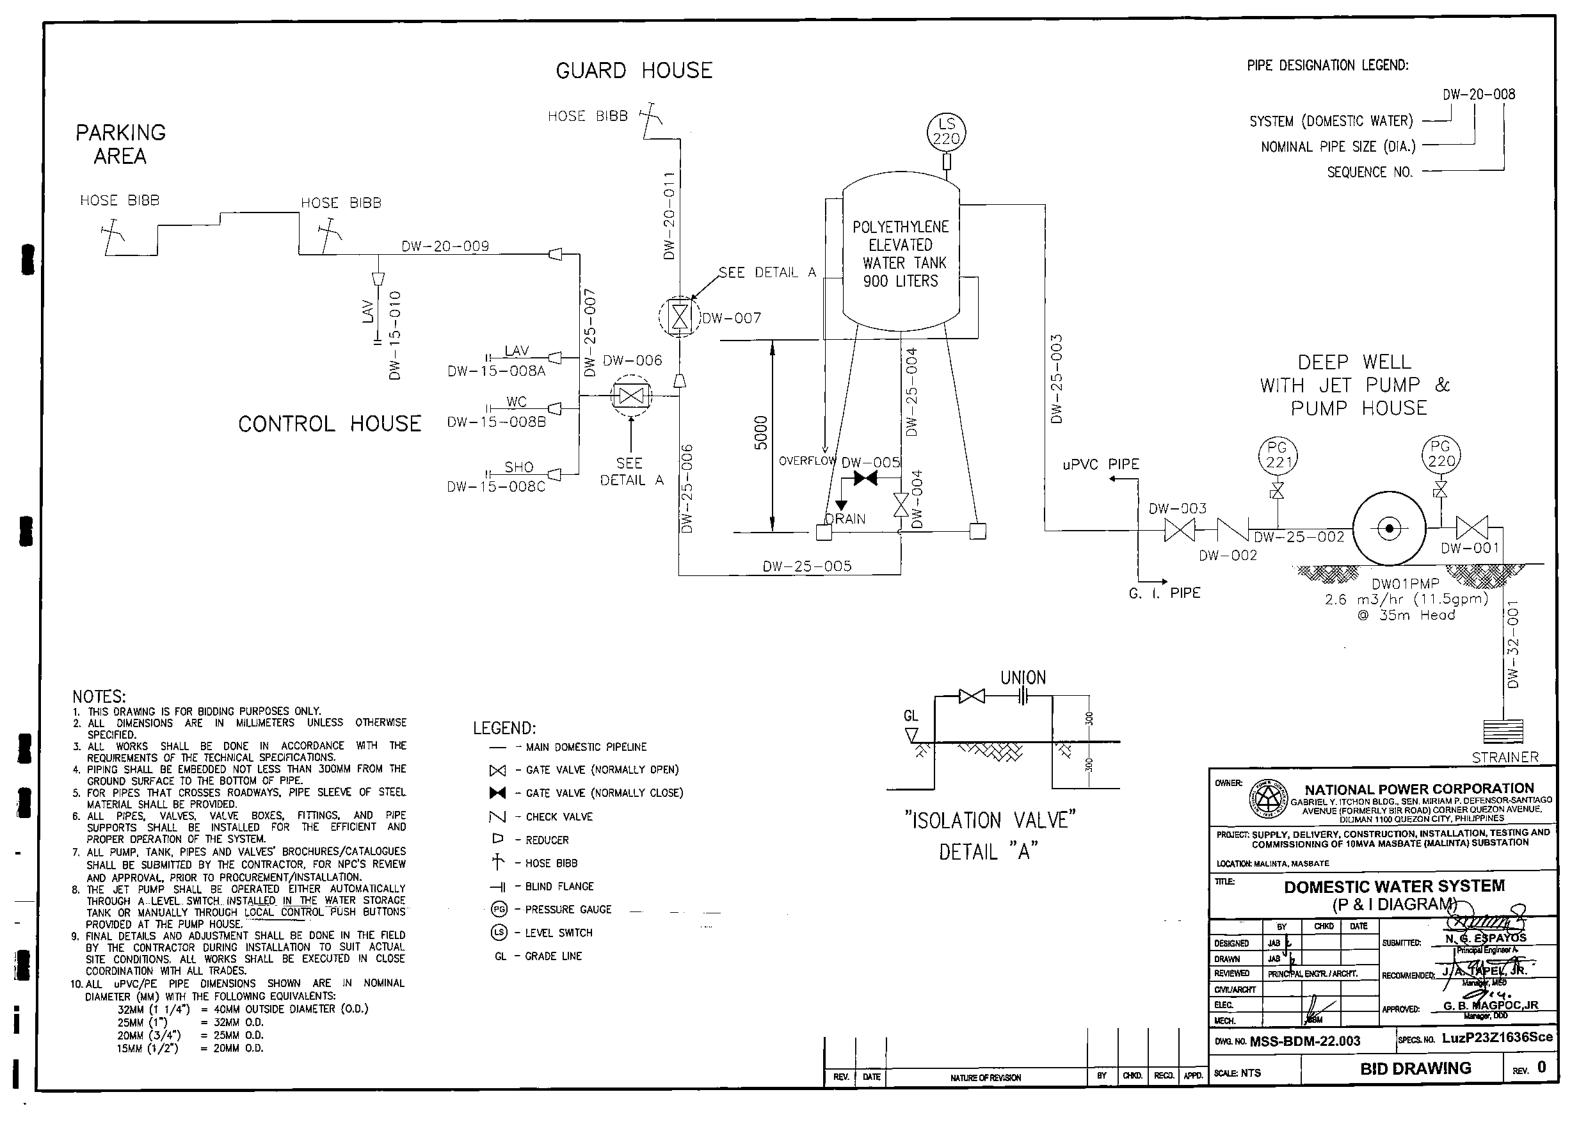

NATURE OF REVISION


# NOTES:

- 1. THIS DRAWING IS FOR BIDDING PURPOSES ONLY.
- ALL DIMENSIONS ARE IN MILLIMETERS UNLESS OTHERWISE SPECIFIED.
- 3. EQUIPMENT TO BE FURNISHED SHALL BE DESIGNED & CONSTRUCTED IN ACCORDANCE WITH THE REQUIREMENTS OF THE SPECIFICATIONS & SHALL FIT INTO THE SPACE AVAILABLE WITH PROPER REGARD TO ACCESSIBILITY, PASSAGEWAY, HANDLING AND STRUCTURE LIMITATIONS.
- 4. ALL WORKS SHALL BE DONE IN ACCORDANCE WITH THE REQUIREMENTS OF THE TECHNICAL SPECIFICATIONS.
- THE JET PUMP SHALL BE OPERATED EITHER AUTOMATICALLY THROUGH A LEVEL SWITCH INSTALLED IN THE WATER STORAGE TANK OR MANUALLY THROUGH LOCAL CONTROL PUSH BUTTONS PROVIDED AT THE PUMP HOUSE.
- PIPING, VALVES, FITTINGS AND OTHER ACCESSORIES SHALL BE PROVIDED TO CONFORM WITH THE REQUIREMENTS OF THE TECHNICAL SPECIFICATIONS.
- THIS DRAWING SHOWS A TYPICAL INSTALLATION OF A WELL. THE CONTRACTOR SHALL PROVIDE FINAL DESIGN AND DETAILS FOR NPC REVIEW AND APPROVAL.

# LEGEND:

- CHECK VALVE

PO - PRESSURE GAUGE

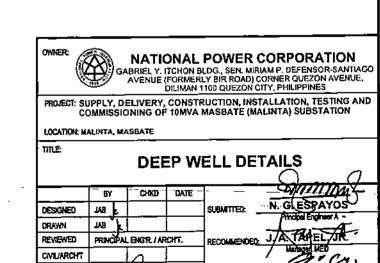

DWG. NO. MSS-BDM-22.004

ELEC.

BY CHKO, RECO. APPO.

SPECS, NO. LuzP23Z1636Sce

G. B. MAGPOC, JR

SCALE: NTS BID DRAWING

RAWING REV. 0

